AND/OR THE CITY OF O'FALLON. IT SHALL BE THE RESPONSIBILITY OF THE CONTRACTOR TO RESTORE THE GRADE TO

HE DESIGN ELEVATIONS. NO SLOPES SHALL EXCEED 3:1 (HORIZONTAL: VERTICAL).

ONLY THE DESIGNATED CONSTRUCTION ACCESS ROUTE MAY BE USED TO MOVE EQUIPMENT IN

ALL SILTATION MEASURES MUST BE IN PLACE BEFORE ANY OPERATIONS THAT DISTURB THE NATURAL GRADE A TRACT OF LAND BEING PART OF THE SOUTHEAST QUARTER OF THE NORTHEAST QUARTER COMPLETION OF ALL SILTATION AND EROSION FACILITIES AND SHALL INSPECT AND APPROVE SUCH FACILITIES AND SHALL INSPECT AND APPROVE S

TO THE COMMENCEMENT OF ANY CLEARING OR GRADING ACTIVITIES SILTATION CONTROL FACILITIES MUST BE MAINTAINED THROUGHOUT THE ENTIRE CONSTRUCTION PERIOD. THIS INCLUDES REMOVAL OF MUD FROM SILTATION BASINS AND REPLACEMENT OF STRAW BALES. MUD SHALL NOT BE PERMITTED TO MIGRATE OFF THE SITE. DAMAGE OR FAILURE OF SILTATION AND EROSION CONTROL FACILITIES SHALL BE REPAIRED IMMEDIATELY BUT NOT LONGER THAN 24 HOURS AFTER NOTIFICATION. IF PROPOSED MEASURES FAIL TO ADEQUATELY PROTECT THE ADJOINING PROPERTY ADDITIONAL FACILITIES SHALL BE INSTALLED

THE ENGINEER SHALL NOT BE RESPONSIBLE FOR THE MEANS, METHODS, TECHNIQUES, SEQUENCE OR PROCEDURES OF CONSTRUCTION SELECTED BY THE CONTRACTOR TO PROTECT OFF-SITE ROPERTY FROM EROSION OR SILTATION. THE ENGINEER SHALL NOT BE LIABLE FOR DAMAGE

CAUSED BY EROSION OR SILTATION DUE TO DEFECTIVE SILTATION CONTROL DEVICES.
MUD WILL NOT BE PERMITTED TO BE CARRIED OFF SITE ONTO PUBLIC STREETS. A TEMPORARY WASH FACILITY SHALL BE PROVIDED TO REMOVE MUD FROM VEHICLE TIRES BEFORE ENTERING MEASURES SHALL BE TAKEN TO CONTROL DUST AS NECESSARY.

IT SHALL BE THE GRADING CONTRACTOR'S RESPONSIBILITY TO NOTIFY THE SOILS ENGINEER OF WORK IN PROGRESS AND TO COMPLY WITH SPECIFICATIONS SET BY THE SOILS ENGINEER WITH

GARD TO COMPACTION, SURFACE PREPARATION AND PLACEMENT OF FILL L STUMPS, LIMBS, AND OTHER DEBRIS ARE TO BE REMOVED FROM THE SITE.

ALL DRAINAGE SWALES SHALL BE SODDED.

ALL FILL AREAS, INCLUDING TRENCH BACKFILLS, UNDER BUILDINGS, PROPOSED STORM AND SANITARY SEWER LINES, PUBLIC RIGHT OF WAY AND PAVED AREAS SHALL BE COMPACTED TO 90% OF MAXIMUM DENSITY AS DETERMINED BY THE MODIFIED AASHO T-180 COMPACTION TEST, (A.S.T.M. D-1557) UNLESS OTHERWISE REQUIRED IN THE SOILS REPORT FOR THIS PROJECT.

DEVELOPER MUST SUPPLY CITY CONSTRUCTION INSPECTORS WITH SOIL REPORTS PRIOR TO OR DURING

"THE CONTRACTOR SHALL ASSUME COMPLETE RESPONSIBILITY FOR CONTROLLING ALL SILTATION AND EROSION OF THE PROJECT AREA. THE CONTRACTOR SHALL USE WHATEVER MEANS NECESSARY TO CONTROL EROSION AND SILTATION INCLUDING, BUT NOT LIMITED TO, STAKED STRAW BALES AND/OR SILTATION FABRIC FENCES (POSSIBLE METHODS OF CONTROL ARE DETAILED IN THE PLAN). CONTROL SHALL COMMENCE WITH GRADING AND BE MAINTAINED THROUGHOUT THE PROJECT UNTIL ACCEPTANCE IF THE WORK BY THE OWNER AND/OR THE CITY OF O'FALLON AND/OR MODOT. THE CONTRACTOR'S RESPONSIBILITIES INCLUDE ALL DEIGN AND IMPLEMENTATION AS REQUIRED TO PREVENT EROSION AND THE DEPOSITING OF SILT. THE OWNER AND/OR THE CITY OF O'FALLON AND/OR MODOT MAY AT THEIR OPTION DIRECT THE CONTRACTOR IN HISS METHODS AS DEEMED FIT TO PROTECT PROPERTY AND MPROVEMENT, ANY DEPOSITING OF SILT OR MUD ON NEW OR EXISTING PAVEMENT SHALL BE REMOVED IMMEDIATELY, ANY DEPOSITING OF SILTS OR MUD IN NEW OR EXISTING STORM SEWERS STORM SEWERS OR SWALES SHALL BE REMOVED AFTER EACH RAIN AND AFFECTED AREAS CLEANED TO THE ATISFACTION OF THE OWNER AND/OR THE CITY OF O'FALLON AND/OR MODOT

"ALL FILL PLACED UNDER PROPOSED STORM AND SANITARY SEWER, PROPOSED ROADS, AND/OR PAVED AREAS SHALL BE COMPACTED TO 90% OF MAXIMUM DENSITY AS DETERMINED BY THE MODIFIED AASHTO T-180 COMPACTION TEST OR 95% OF MAXIMUM DENSITY AS DETERMINED BY THE STANDARD PROCTOR TEST AASHTO T-99. ALL FILL PACED IN PROPOSED ROADS SHALL BE COMPACTED FROM THE BOTTOM OF THE FILL UP. ALL TESTS SHALL BE VERIFIED BY A SOILS ENGINEER CONCURRENT WITH GRADING AND BACKFILLING OPERATIONS." ENSURE THE MOISTURE CONTENT OF THE SOIL IN FILL AREAS IS TO CORRESPOND TO THE COMPACTIVE EFFORT AS DEFINED BY THE STANDARD OR MODIFIED PROCTOR TEST, OPTIMUM MOISTURE CONTENT SHALL BE DETERMINED USING THE SAME TEST THAT WAS USED FOR COMPACTION. SOIL COMPACTION CURVES SHALL BE SUBMITTED TO THE CITY OF O'FALLON PRIOR TO THE PLACEMENT OF FILL. PROOF ROLLING MAY BE REQUIRED TO VERITY SOIL STABILITY AT THE DISCRETION OF THE CITY OF O'FALLON.

GRADING AREAS THAT ARE TO REMAIN BARE FOR OVER 2 WEEKS SHALL BE SEEDED AND MULCHED. ALL EROSION CONTROL SYSTEMS SHALL BE INSPECTED AND NECESSARY CORRECTIONS MADE WITHIN 24 HOURS OF ANY RAINSTORM RESULTING IN ONE-HALF INCH OF RAIN OR MORE

ALL PAVEMENT CONSTRUCTION SHALL BE IN ACCORDANCE WITH THE ST. CHARLES COUNTY TANDARDS AND SPECIFICATIONS EXCEPT AS MODIFIED BY THE CITY OF O'FALLON ORDINANCES.

SHALL BE THE CONTRACTORS RESPONSIBILITY TO COORDINATE THE INSTALLATION OF UTILITIES TO AVOID ANY CONFLICT WITH CONSTRUCTION.

THE CONTRACTOR SHALL BE RESPONSIBLE FOR ENSURING THAT THE SUBGRADE MEETS THE ST. CHARLES OUNTY DEPARTMENT OF TRAFFIC'S SPECIFICATIONS FOR COMPACTION PRIOR TO THE PLACEMENTS OF E GRANULAR BASE AND THAT THE SUBGRADE AND GRANULAR BASE MEETS THE COUNTY'S AND/OR CITY'S SPECIFICATIONS FOR COMPACTION PRIOR TO THE PLACEMENT OF THE PAVEMENT. PROVIDE ADEQUATE TEMPORARY OFF-STREET PARKING FOR CONSTRUCTION EMPLOYEES. PARKING ON

NON-SURFACED AREAS SHALL BE PROHIBITED IN ORDER TO ELIMINATE THE CONDITION WHEREBY MUD FROM CONSTRUCTION AND EMPLOYEE VEHICLES IS TRACKED ONTO THE PAVEMENT CAUSING HAZARDOUS ROADWAY AND DRIVING CONDITIONS ENSURE SIDEWALKS: CURB RAMPS, RAMP AND ACCESSIBLE PARKING SPACES SHALL BE CONSTRUCTED IN ACCORDANCE WITH THE CURRENT APPROVED "AMERICAN WITH DISABILITIES ACT ACCESSIBILITY

GUIDELINES" (ADAAG) ALONG WITH THE REQUIRED GRADES, CONSTRUCTION MATERIALS, SPECIFICATIONS AND SIGNAGE, IF ANY CONFLICT OCCURS BETWEEN THE ABOVE INFORMATION AND THE PLANS, THE ADAAG GUIDELINES SHALL TAKE PRECEDENCE AND THE CONTRACTOR PRIOR TO ANY CONSTRUCTION SHALL NOTIFY THE PROJECT ENGINEER (ENSURE AT LEAST ONE 8' WIDE HANDICAP ACCESS AISLE I PROVIDED AND CURB RAMPS DO NOT PROJECT INTO HANDICAP ACCESS AISLE.

ALL SEWER CONSTRUCTION AND MATERIALS TO BE IN ACCORDANCE WITH THE CITY OF O'FALLON SEWER COMPANY

ALL SEWER CONSTRUCTION METHODS TO CONFORM TO THE LATEST STANDARDS AND SPECIFICATIONS OF THE APPLICABLE PLUMBING CODES. AFTER ALL SEWERS AND APPURTENANCES ARE COMPLETED, INSPECTED, AND ACCEPTED, THE CONTRACTOR

WILL BE PERMITTED TO CONNECT THE SEWER EXTENSION INTO THE EXISTING SYSTEM, IN THE PRESENCE ALL P.V.C. PIPE SHALL CONFORM TO ASTM D-3034, TYPE PSM WITH A SDR RATING OF 35 OR LOWER. JOINTING MATERIAL FOR POLYVINYL CHLORIDE (P.V.C.) SANITARY SEWERS SHALL CONFORM TO A.S.T.M.

ALL REINFORCED CONCRETE PIPE SHALL CONFORM TO ASTM DESIGNATION C76-67, CLASS III, EXCEPT ALL CONCRETE PIPE SHALL CONFORM TO ASTM DESIGNATION C14-67, STANDARD STRENGTH, EXCEPT AS

MANHOLE FRAMES AND COVERS SHALL BE STANDARD FRAMES AND COVERS AS APPROVED BY THE

TRENCHES UNDER EXISTING PAVING AND UNDER AREAS TO BE PAVED, AND ALL TRENCHES WITHIN THE ROAD RIGHT OF WAY SHALL BE GRANULARLY BACKFILLED WITH 3/4" CRUSHED LIMESTONE AND

COMPACTED BY JETTING "ALL FILL PLACED UNDER PROPOSED STORM AND SANITARY SEWER, PROPOSED ROADS, AND/OR PAVED AREAS SHALL BE COMPACTED TO 90% OF MAXIMUM DENSITY AS DETERMINED BY THE MODIFIED AASHTO T-180 COMPACTION TEST OR 95% OF MAXIMUM DENSITY AS DETERMINED BY THE STANDARD PROCTOR TEST AASHTO T-99, PRIOR TO EXCAVATING AND INSTALLING THE PIPE. TESTS SHALL BE TAKEN AT A MAXIMUM OF FIFTY (50) FOOT INTERVALS ALONG THE ROUTE OF THE PIPE; AT A MAXIMUM OF TWO FOOT VERTICALLY; AND LATERALLY ON EACH SIDE OF THE PIPE, AT A DISTANCE EQUAL TO THE DEPTH

THE SEWER CONTRACTOR MAY CONSTRUCT THE BUILDING SEWER LATERALS IN CONJUNCTION WITH THE SANITARY MAIN, TRUNK, OR LATERAL SEWERS WITHIN THE DEVELOPMENT, AS LONG AS THE BUILDING SEWER LATERAL TERMINATES FIVE (5) FEET OR MORE OUTSIDE OF THE PROPOSED OR EXISTING BUILDING LINE OR FOUNDATION WALL

THE MINIMUM VERTICAL DISTANCE FROM THE LOW POINT OF A SANITARY SEWER AT THE CORRESPONDING BUILDING CONNECTION SHALL NOT BE LESS THAN THE DIAMETER OF THE SEWER PLUS A VERTICAL DISTANCE OF 2-1/2 FEET.

IT IS THE CONTRACTOR'S RESPONSIBILITY TO PROVIDE THE LOCATION OF EXISTING UTILITIES AND/OR UNDERGROUND FACILITIES BY NOTIFYING THE UTILITY COMPANIES PRIOR TO CONSTRUCTION. THE DEVELOPER SHALL BE ON FILE WITH THE MISSOURI ONE CALL SYSTEM PRIOR TO ANY WORK BEGINNING ON THE PROJECT (1-800-344-7483).

GAS, WATER, AND OTHER UNDERGROUND UTILITIES SHALL NOT CONFLICT WITH THE DEPTH OR HORIZONTAL LOCATION OF EXISTING AND PROPOSED SANITARY AND STORM SEWERS, INCLUDING HOUSE

ALL STANDARD STREET CURB INLETS ARE TO HAVE THE FRONT OF THE INLET TWO FEET BEHIND THE BACK OF CURB, UNLESS NOTED OTHERWISE. ALL STORMWATER SHALL BE DISCHARGED AT AN ADEQUATE NATURAL DISCHARGE POINT

SINKHOLES ARE NOT ADEQUATE NATURAL DISCHARGE POINTS.
WHEN P.V.C. PIPE IS USED, APPROPRIATE RUBBER SEAL WATERSTOP, AS APPROVED BY THE CITY.
SHALL BE INSTALLED BETWEEN P.V.C. PIPE AND CONCRETE OR BRICK STRUCTURE.

ALL CONSTRUCTION AND MATERIALS USED SHALL CONFORM TO CURRENT APPLICABLE STANDARDS BRICK SHALL NOT BE USED IN THE CONSTRUCTION OF STORM OR SANITARY SEWER STRUCTURES. ALL JOINTS SHALL BE GASKETED O-RING TYPE.

ALL INLETS SHALL HAVE 5/8" DIAMETER TRASH BAR.

RIP RAP SHOWN AT FLARED ENDS WILL BE EVALUATED IN THE FIELD AFTER INSTALLATION FOR EFFECTIVENESS AND FIELD MODIFIED IF NECESSARY TO REDUCE EROSION ON AND OFF SITE. ALL SANITARY LATERALS AND SANITARY MAINS CROSSING UNDER ROADWAYS MUST HAVE THE PROPER ROCK BACKFILL AND TO REQUIRED COMPACTION.

ALL SEWER STRUCTURES SHALL HAVE A 0.20' DROP THROUGH ALL SEWER STRUCTURES. DROP SEWER STRUCTURES SHALL HAVE COMPACTED ROCK BACKFILL IN THE DISTURBED GROUND AROUND THE STRUCTURE.


1. LIGHTING VALUES WILL BE REVIEWED ON SITE PRIOR TO THE FINAL OCCUPANCY INSPECTION. CORRECTIONS WILL NEED TO BE MADE IF NOT IN COMPLIANCE WITH CITY STANDARDS. ALL UTILITIES WILL BE LOCATED UNDERGROUND. ALL SIGN LOCATIONS AND SIZES MUST BE APPROVED SEPERATELY THROUGH THE PLANNING DIVISION.

SIGN LOCATIONS ARE SHOWN ON THE PLANS. ALL SIGN POST, BACKS AND BRAKET ARMS SHALL BE PAINTED BLACK USING CARBOLINE RUSTBOND PENETRATING SEALER SG AND CARBOLINE 1.33 HB PAINT (OR EQUIVILENT AS APPROVED BY CITY AN MODOT). SIGNS DESIGNATING STREET NAME SHALL BE ON THE OPPOSITE SIDE OF THE STREET FROM TRAFFIC CONTROL SIGNS.

5. ALL UTILITIES WILL BE LOCATED UNDERGROUND. ALL REQUIREMENTS OF THE PLANNING AND ZONING COMMISSION ARE ADDRESSED.

"AS-BUILT" **JACK IN THE BOX #4047**

OF SECTION 29, TOWNSHIP 47 NORTH, RANGE 3 EAST IN THE CITY OF O' FALLON, ST. CHARLES COUNTY, MISSOURI

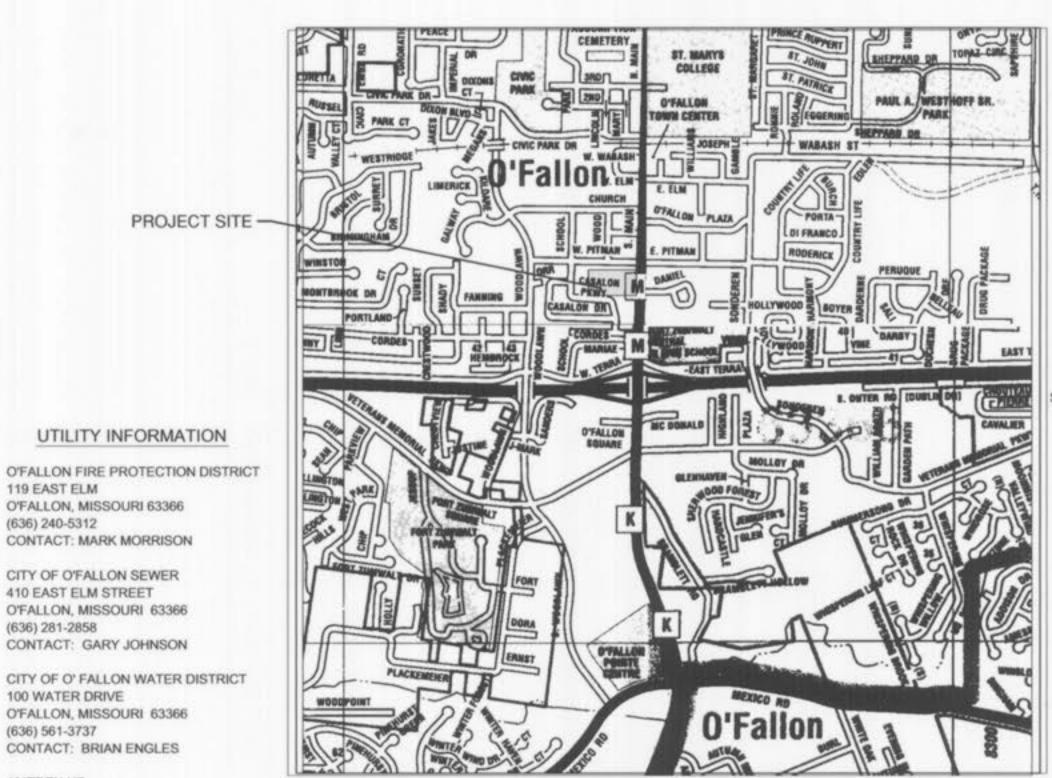

UTILITY INFORMATION

119 EAST ELM

(636) 240-5312

(636) 281-2858

(636) 561-3737

AMEREN UE

(800) 552-7583

100 WATER DRIVE

O'FALLON, MISSOURI 63366

CONTACT: MARK MORRISON

CITY OF O'FALLON SEWER

O'FALLON, MISSOURI 63366

CONTACT: GARY JOHNSON

O'FALLON, MISSOURI 63366

CONTACT: BRIAN ENGLES

200 CALLAHAN ROAD

WENTZVILLE, MO. 63385

CONTACT: ENGINEERING

LACLEDE GAS COMPANY

ST. LOUIS, MISSOURI 63101

CENTURY-TEL TELEPHONE

1151 CENTURY-TEL DRIVE

CONTACT: CARL OWENS

3660 SOUTH GEYER ROAD

SUNSET HILLS, MISSOURI 63127

CONTACT: CYNTHIA COLTHORY

WENTZVILLE, MISSOURI 63385

CHARTER COMMUNICATIONS (CABLE TV)

BUILDING SETBACKS:

FRONT YARD SETBACK = 25'

REAR YARD SETBACK = 10'

PARKING CALCULATIONS

TOTAL PARKING REQUIRED:

TOTAL PARKING PROVIDED:

TOTAL SPACES REQUIRED =

TOTAL SPACES PROVIDED =

 $(47 \div 15) = 3.13$

TOTAL STACKING SPACE REQUIRED:

TOTAL STACKING SPACE PROVIDED:

BICYCLE PARKING REQUIREMENTS

(1 BIKE SPACE PER 15 CAR SPACES PROVIDED)

BEFORE YOU

DIG - DRILL - BLAST

(TOLL FREE)

1-800-344-7483

MISSOURI ONE CALL SYSTEM, INC

MODOT LOCATE (314) 340-4100

(THIS NUMBER INCLUDES 2 ACCESSIBLE SPACES)

720 OLIVE STREET

CONTACT: DAN RYAN

(314) 342-0782

(636) 332-7392

(314) 579-4874

410 EAST ELM STREET

LOCATION MAP WUNNENBERG'S STREET GUIDE

CITY OF O' FALLON, ST. CHARLES COUNTY, MISSOURI

PAGE 30, GRID SS-15

ZIP CODE: MUNICIPALITY:

PROPERTY ADDRESS: 415 SOUTH MAIN

PARCEL NUMBER: TOTAL SITE AREA: EXISTING ZONING:

REQUIRED FOR RESTAURANT (FAST FOOD) = 20 SPACES + 1 SPACE PER 100 SQ. FT. OF FLOOR AREA (2,645 SQ. FT.)

4 SPACES

4 SPACES

 $[20 + (2,645 \div 100)] = 46.45 \text{ SPACES}$

083.000 34,682 SQ. FT. 0.796 ACRES "C-2" GENERAL BUSINESS DISTRICT

PROPOSED USE: OWNER:

JACK IN THE BOX EASTERN DIVISION, L.P. A TEXAS LIMITED PARTNERSHIP

STATION SC-53 MISSOURI DEPARTMENT OF NATURAL RESOURCES

OF A NAIL AND SHINER IN UTILITY POLE. ELEV. = 465.8783

WITH THE UNDERGROUND FACILITY SAFETY AND DAMAGE PREVENTION ACT, CHAPTER 319, RSMO.

THE STATION IS LOCATED ABOUT 1 MILE NORTH OF O' FALLON, MO., ON THE NORTH SIDE OF

ASPHALT: 2.4 FEET SOUTH OF A CARSONITE WITNESS POST: 57.3 FEET EAST OF A NAIL AND

SHINER IN AN UNDERGROUND UTILITIES WARNING SIGN POST AND 97.5 FEET EAST-NORTHEAST

THE UNDERGROUND UTILITIES SHOWN HEREIN WERE PLOTTED FROM AVAILABLE INFORMATION AND DO NOT NECESSARILY REFLECT THE ACTUAL

EXISTENCE, NONEXISTENCE, SIZE, TYPE, NUMBER OR LOCATION OF THESE OR OTHER UTILITIES. THE GENERAL CONTRACTOR SHALL BE RESPONSIBLE

FOR VERIFYING THE ACTUAL LOCATION OF ALL UTILITIES, SHOWN OR NOT SHOWN, AND SAID UTILITIES SHALL BE LOCATED IN THE FIELD PRIOR TO ANY GRADING, EXCAVATION OR CONSTRUCTION OF IMPROVEMENTS. THESE PROVISIONS SHALL IN NO WAY ABSOLVE ANY PARTY FROM COMPLYING

MISSOURI ROUTE P. IT IS 67.5 FEET NORTH OF THE CENTER OF ROUTE P; 12 FEET WEST OF

THE CENTER OF AN ASPHALT ENTRANCE; 7.9 FEET WEST-SOUTHWEST OF A 80D NAIL IN

UTILITY LOCATION NOTE

SITE INFORMATION

63366

CITY OF O'FALLON

= 47 SPACES

= 47 SPACES

10 SPACES

6 TO 12 SPACES

RESTAURANT

C7 OF 10 DISABLE ACCESS SITE PLAN AND DETAIL SHEET

LEGEND OF SYMBOLS

EXISTING SYMBOL-

F.H.

O-GM

0-0.0.

O-W.V.

- 646

TC 646.45

FG 646.45

TW 646.45

BW 646.45

TB 646.45

BB 646.45

PROPOSED SYMBO

FH

G.M.

-00

0 W.V.

= 646.4

TW = 646.45

-x-x-x-x

-000000000

OBJECT/CONDITION REPRESENTED BY SYMBOL

UTILITY POLE WITH GUY WIRE

ELECTRIC LINE (OVERHEAD)

TELEPHONE LINE (OVERHEAD)

MANHOLE WITH STORM SEWER

MANHOLE WITH SANITARY SEWER

SPOT ELEVATION AT TOP OF CURB

SPOT ELEVATION AT TOP OF WALI

SPOT ELEVATION AT BOTTOM OF WAL

SPOT ELEVATION AT BOTTOM OF BANK

SPOT ELEVATION AT TOP OF BANK

SILTATION CONTROL DEVICES

SPOT ELEVATION AT FLOWLINE OF GUTTER

INLET WITH STORM SEWER

ELECTRIC LINE (UNDERGROUND)

TELEPHONE LINE (UNDERGROUND)

UTILITY POLE

WATER LINE

INLET NUMBER

FIRE HYDRAN

GAS VALVE

GAS METER

CLEAN OUT

CONTOUR

WATER VALVE

WATER METER

SPOT ELEVATION

STREET SIGN

C1 OF 10

MANHOLE NUMBER

GAS LINE

C8 OF 10 SEWER PROFILES AND DETAILS

SHEET INDEX

ALTA/ACSM LAND TITLE SURVEY

SITE AND DEMOLITION PLAN

COVER SHEET

GRADING PLAN

UTILITY PLAN

C9 OF 10 DRAINAGE AREA MAP, DETAIL SHEET AND SITE SECTION

= 9,277 SQ. FT. (26%)

C10 OF 10 DETAIL SHEET

C6 OF 10 DETAIL SHEET

SITE CALCULATIONS

GREEN SPACE

PAVEMENT AREA = 22,760 SQ. FT. (66%)

BUILDING AREA = 2,645 SQ. FT. (8%) FINAL MEASUREMENT DRAWING

AS OF 10/26/06 . I CERTIFY THAT THESE "AS BUILT" DRAWINGS INDICATE THE ACTUAL LOCATION, LENGTH, SIZE AND TYPE OF PIPE(S), FLOWLINES, DEPTHS, STRUCTURES, WYE LOCATIONS (AS PROVIDED BY OTHERS), AS APPROPRIATE, AND THAT THE PUBLIC SEWERS HAVE BEEN CONSTRUCTED WITHIN EXISTING OR PROPOSED EASEMENTS AS SHOWN ON THE SUBDIVISION PLAT WITH THE EXCEPTION OF THE FOLLOWING:

NONE

POEHLMAN & PROST, INC.

ABBREVIATIONS INDEX

BOTTOM OF SLOPE ELEVATION

BOTTOM OF WALL ELEVATION

CORRUGATED METAL PIPE

BOTTOM OF LOADING DOCK ELEVATION

ADJUST TO GRADE

BENCHMARK

CLEAN OUT

CONCRETE

DEED BOOK

DOWNSPOUT

ELEVATION

EASEMENT

ELEV

ESMT

EXIST

LOC #

MIN

MAX

MON

MSD

N/F

PERM

PG PVC PVMT

RAR

REC

R/W

CONCRETE PIPE

DUCTILE IRON PIPE

EDGE OF ASPHALT

EDGE OF PAVEMENT

EDGE OF SHOULDER

FOUND IRON PIPE

CURVE LENGTH

MANHOLE

MINIMUM

MONUMENT

NORTHEAST

NORTHWEST

OLD AXLE

OLD STONE

PLAT BOOK

PAVEMENT

PERMANENT

RIGHT OF WAY

RIGHT OF WAY

SET IRON PIPE

SQUARE FEET

SEWER VENT

SOUTH WEST

TO BE REMOVED

TOP OF CURB ELEVATION

TOP OF RAIL ELEVATION

TOP OF SLOPE ELEVATION

TOP OF WALL ELEVATION

VITRIFIED CLAY PIPE

TOP OF FOUNDATION ELEVATION

TOP OF LOADING DOCK ELEVATION

RAILROAD

SOUTHEAST

SURVEY

POLYVINYL CHLORIDE PIPE

REINFORCED CONCRETE PIPE

REMOVE AND REPLACE

OLD IRON PIPE

OLD IRON ROD

LOCATOR NUMBER

NOW OR FORMERLY

FLOW LINE ELEVATION

FINISH FLOOR ELEVATION

FLOWLINE OF GUTTER ELEVATION

METROPOLITAN ST. LOUIS SEWER DISTRICT

ENGINEERING/SURVEYING AUTHENTICATION

THE RESPONSIBILITY FOR PROFESSIONAL ENGINEERING/SURVEYING LIABILITY ON THIS PROJECT IS HEREBY LIMITED TO THE SET OF PLANS AUTHENTICATED BY THE SEAL, SIGNATURE AND DATE HERE UNDER ATTACHED. RESPONSIBILITY IS DISCLAIMED FOR ALL OTHER ENGINEERING/SURVEYING PLANS INVOLVED IN THE PROJECT AND SPECIFICALLY EXCLUDES REVISIONS AFTER THIS DATE UNLESS RE-AUTHENTICATED.

ENGINEERING/SURVEYING RELEASE

THE ORIGINAL OF THIS DRAWING IS ON FILE AT THE OFFICE OF POEHLMAN & PROST, INC. ANY MODIFICATIONS TO THIS DRAWING SHALL RELEASE SAID POEHLMAN & PROST, INC., THE ENGINEER AND/OR SURVEYOR WHOSE SEAL APPEARS HEREON FROM ANY LIABILITY RESULTING FROM SAID UNAUTHORIZED MODIFICATIONS.

PLANNING & ZONING FILE # 3402.01

		Revised: 2-16-05 (PLANNING) 3-24-05 (CITY)
DRAWN BY: S. SMITH	1-28-05	4-5-05 4-28-05 (CONST.) 5-12-05 (CITY)
CHECKED BY: T. HAMILTON	1-28-05	5-19-05 10-5-05 (ENTRANCE) 10-24-05(ENTRANCE) 10-26-05
PROOFED #	DATE	11-01-05 12-12-05 AS-BUILTS
	DRAWN BY: S. SMITH CHECKED BY: T. HAMILTON	DRAWN BY: S. SMITH 1-28-05 CHECKED BY: T. HAMILTON 1-28-05

O'FALLON, MISSOURI

NOVA GROUP, INC. (314)731-5353 FAX (314)731-5423

10-26-06

204-169-A C1 OF 10



9330 BALBOA AVENUE SAN DIEGO, CA 92123

D 1999 Jack in the Box Inc are the property of Jack in the Box In and shall not be copied or reproduce

without its previous written consen-

dates

RELEASE: P.M.(JIB DNLY)

3-03-09 3-03-0

CONSTRUCTION:

revisions

 \mathbf{Z}

site information

MK TYPE 8ECBSQ44

JIB #: #4047/Q.S.#

ADDRESS: 415 S. MAIN

J' FALLON, MO BRAWN BY:

COVER SHEET

6312 HAZELWEST COURT, #102 HAZELWOOD, MISSOURI 63042

COVER SHEET

LEGAL DESCRIPTION

LAND DESCRIPTION

A TRACT OF LAND BEING PART OF THE SOUTHEAST QUARTER OF THE NORTHEAST QUARTER OF SECTION 29, TOWNSHIP 47 NORTH, RANGE 3 EAST IN THE CITY OF O'FALLON, ST. CHARLES COUNTY, MISSOURI, AND BEING MORE PARTICULALARY DESCRIBED

COMMENCING AT THE POINT OF INTERSECTION OF THE SOUTH RIGHT OF WAY LINE OF PITMAN ROAD, 40.00 FEET WIDE WITH THE WEST RIGHT OF WAY LINE OF STATE HIGHWAY ROUTE "M". HAVE A VARIABLE WIDTH: THENCE SOUTH OO DEGREES 40 MINUTES OO SECONDS WEST ALONG SAID WESTERN RIGHT OF WAY OF ROUTE "M" A DISTANCE OF 285.80 FEET TO AN OLD CROSS MARKING THE SOUTHEAST CORNER OF A TRACT OF LAND NOW OR FORMERLY CONVEYED TO ARTHUR A. TEGETHOFF AND HIS WIFE DOROTHY A. RECORDED IN DEED BOOK 911, PAGE 748 OF THE ST. CHARLES COUNTY RECORDERS OFFICE, SAID POINT ALSO BEING THE POINT OF BEGINNING OF THE TRACT DESCRIBED HEREIN: THENCE CONTINUING ALONG SAID WESTERN RIGHT OF WAY LINE SOUTH OO DEGREES 40 MINUTES DO SECONDS WEST A DISTANCE OF 134.00 FEET TO A POINT; THENCE DEPARTING SAID ROUTE "M" NORTH 89 DEGREES 09 MINUTES 52 SECONDS WEST A DISTANCE OF 258.95 FEET TO A POINT: THENCE NORTH OO DEGREES 46 MINUTES 35 SECONDS EAST A DISTANCE OF 134.00 FEET TO A POINT: THENCE SOUTH 89 DEGREES 09 MINUTES 52 SECONDS EAST A DISTANCE OF 258.69 FEET TO THE POINT OF BEGINNING CONTAINING 34,682 SQUARE FEET OR 0.796 ACRES.

204-169

SURVEYOR'S CERTIFICATION

HEREBY CERTIFY AND REPRESENT TO JACK IN THE BOX EASTERN DIVISION L.P., A TEXAS LIMITED PARTNERSHIP, JACK IN THE BOX INC., A DELAWARE CORPORATION, CNL FUND ADVISORS, INC., A FLORIDA CORPORATION, CNL APF PARTNERS, LP, A DELAWARE LIMITED PARTNERSHIP, AND ITS AFFILIATES/SUCCESSORS AND/OR ASSIGNS, AND TITLE INSURERS AGENCY, INC. AND (a) THIS IS A TRUE AND CORRECT MAP OF SURVEY MADE ON THE GROUND UNDER MY SUPERVISION AND DIRECTION IN ACCORDANCE WITH MINIMUM STANDARD DETAIL REQUIREMENTS OF THE STATE OF MISSOURI (b) THIS MAP OF SURVEY CORRECTLY AND COMPLETELY SHOWS THE LOCATION OF ALL: (i) VISIBLE IMPROVEMENTS AND STRUCTURES, (ii) EASEMENTS AND RIGHTS-OF-WAY, (iii) ENCROACHMENTS, OVERLAPS AND BOUNDARY LINE DISPUTES, (iv) AREAS DEVOTED OR RESTRICTED IN RECIPROCAL EASEMENT AGREEMENTS, AND ALL OTHER MATTERS. VISIBLE ON THE GROUND OR OF RECORD (AS REFLECTED IN THE BELOW REFERENCED TITLE COMMITMENT), OR OF WHICH THE UNDERSIGNED HAS OTHERWISE BEEN ADVISED AS LOCATED ON, ENCUMBERING OR APPURTENANT TO THE PROPERTY, (c) AS SHOWN ON THIS MAP OF SURVEY, INGRESS AND EGRESS TO THE LAND DESCRIBED IN THIS MAP OF SURVEY IS PROVIDED BY ROUTE "M", THE SAME BEING A PAVED AND DEDICATED PUBLIC RIGHT-OF-WAY MAINTAINED BY MISSOURI DEPARTMENT OF TRANSPORTATION; (d) HAVE CONSULTED THE APPLICABLE FEDERAL FLOOD INSURANCE MAP, NO. 29183C0237-E, DATED AUGUST 2, 1999, AND FOUND THAT THE LAND DESCRIBED IN THIS MAP OF SURVEY IS NOT SITUATED WITHIN A FEDERALLY-DESIGNATED SPECIAL FLOOD HAZARD AREA, (e) THE LAND DESCRIBED IN THIS MAP OF SURVEY IS SUBJECT TO SETBACK, OR HEIGHT RESTRICTIONS OF RECORD PURSUANT TO COMMITMENT FOR TITLE INSURANCE (FILE NO. 00150287), DATED EFFECTIVE DECEMBER 13 2004, ISSUED BY TITLE INSURERS AGENCY, INC. OR DISCLOSED BY APPLICABLE ZONING OR BUILDING CODES OR SUBDIVISION MAPS EXCEPT AS SHOWN ON THIS MAP OF SURVEY, (f) THE LAND DESCRIBED IN THIS MAP OF SURVEY IS THE SAME PROPERTY AS THAT DESCRIBED IN COMMITMENT FOR TITLE INSURANCE (FILE NO. 00150287), DATED EFFECTIVE DECEMBER 13, 2004, ISSUED BY TITLE INSURERS AGENCY,

SURVEY BY: S. BOWLES

POEHLMAN & PROST, INC.

SURVEY NUMBER: 204-169

CHRISTOPHER M. LANEMAN, PROFESSIONAL LAND SURVEYOR. STATE OF MISSOURI #2369

SURVEYOR'S NOTES

- 1. SOURCE OF BEARINGS: ADOPTED S00'40'00"W ON WEST R.O.W. LINE OF ROUTE "M" PER
- 2. THE SURVEYED TRACT CONTAINS 34,682 SQ. FT OR 0.7962 ACRES.
- 3. CLASSIFICATION OF SURVEY: URBAN.
- 4. POEHLMAN & PROST, INC. HAS USED EXCLUSIVELY A TITLE COMMITMENT PREPARED BY TITLE INSURERS AGENCY, INC., A COMMITMENT NUMBER OF 00150287 AND HAVING AN EFFECTIVE DATE OF DECEMBER 13, 2004. THE FOLLOWING ITEMS PERTAIN TO SCHEDULE B-SPECIAL EXCEPTIONS OF THE AFORESAID TITLE COMMITMENT.
- 5. TEN FOOT PERMANENT SEWER LINE EASEMENT GRANTED TO THE CITY OF O'FALLON, ACCORDING TO INSTRUMENT RECORDED IN BOOK 950 PAGE 687, ALONG WITH A 15' WIDE TEMPORARY CONSTRUCTION EASEMENT CONTAINED THEREIN, (SHOWN
- 6. TRACT SUBJECT TO A LEASE BETWEEN LES PROPERTIES AND NAUGLES, INC., DATED MARCH 22, 1981 AND RECORDED IN BOOK 923 PAGE 1426. (NOT PLOTTABLE.)
- 7. CURRENT TITLE COMMITMENT DOES NOT REFLECT A EASEMENT FOR THE STORM SEWER LINE LOCATED ON AND THRU THE SUBJECT PROPERTY

BENCHMARK (DATUM USGS - N.A.V.D. 1988)

STATION NAME SC-53 OF THE MISSOURI GEOGRAPHIC REFERENCE SYSTEM: ELEVATION = 465.88. MISSOURI DNR GRS ALUMINUM DISK STAMPED "SC-53 2000". THIS STAION IS LOCATATED ABOUT 1 MILE NORTH OF O' FALLON, MO., ON THE NORTH SIDE OF MISSOURI ROUTE P. IT IS 67.5 FEET NORTH OF THE CENTER OF ROUTE P; 12 FEET WEST OF THE CENTER OF AN ASPHALT ENTRANCE; 7.9 FEET WEST-SOUTHWEST OF AN 80d NAIL IN ASPHALT; 2.4 FEET SOUTH OF A CARSONITE WITNESS POST; 57.3 FEET EAST OF A NAIL AND SHINER IN AN UNDERGROUND UTILITIES WARNING SIGN POST AND 97.5 FEET EAST-NORTHEAST OF A NAIL AND SHINER IN UTILITY

PLANNING & ZONING FILE # 3402.01

1-28-05 POEHLMAN & PROST, INC. Land Surveying and Civil Engineering SMITH 1-28-05 P.O. Box 8340 5-05 (ENTRANC 1-28-05 9280 Dielman Industrial Drive T. HAMILTON 24-05(ENTRANC St. Louis, Missouri 63132 (314) 997-5777 -BUILTS FAX 997-0407 E-Mail: ppi@poehlman-prost.com JACK IN THE BOX #4047 O'FALLON, MISSOURI 10-26-06 NOVA GROUP, INC. 6312 HAZELWEST COURT, #102 HAZELWOOD, MISSOURI 63042 (314)731-5353 FAX (314)731-5423

ALTA/ACSM LAND TITLE SURVEY

204-169-A C2 OF 10

9330 BALBOA AVENUE SAN DIEGO, CA 92123

© 1999 Jack in the Box are the property of Jack in the B and shall not be copied or repro

without its previous written co

dates

RELEASE: P.M.(JIB DNLY):

CONSTRUCTION:

revisions

Z


site information MK TYPE SECBSQ44

JIB # #4047/Q.S.#


FALLON, MO DRAWN BY:

SCALE

ALTA/ACSM LA TITLE SURVEY

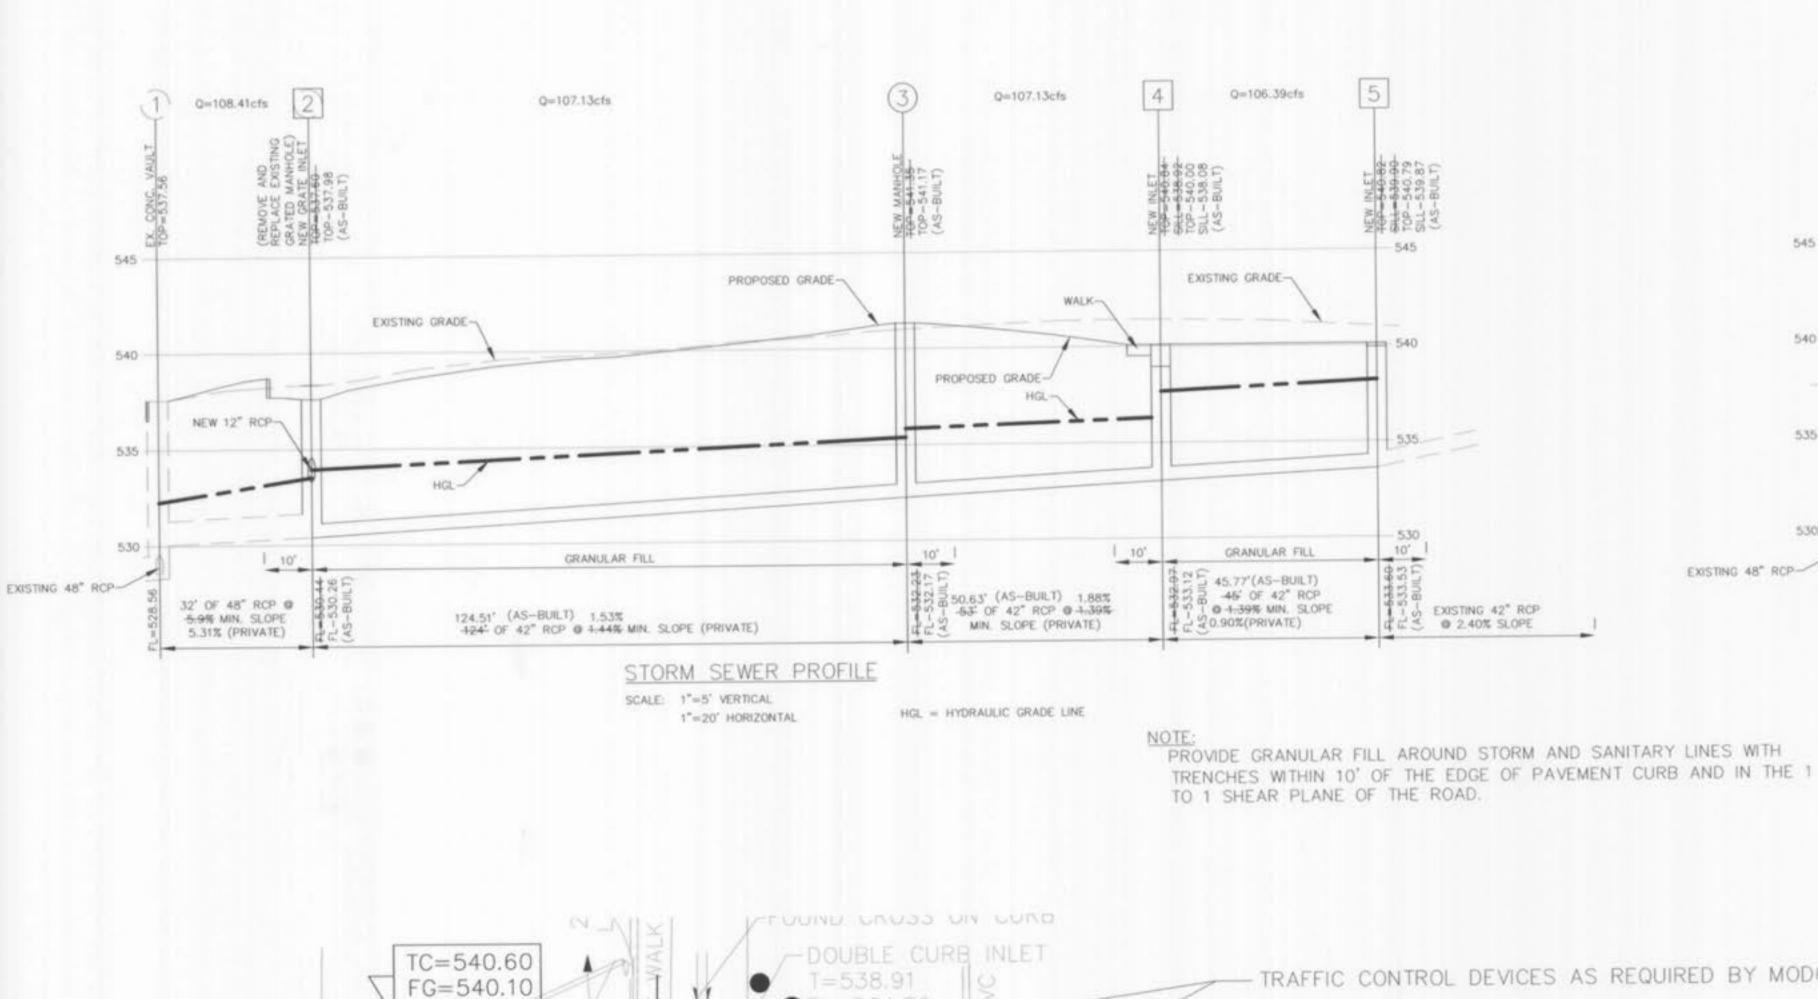


SCALE: 1"=10"

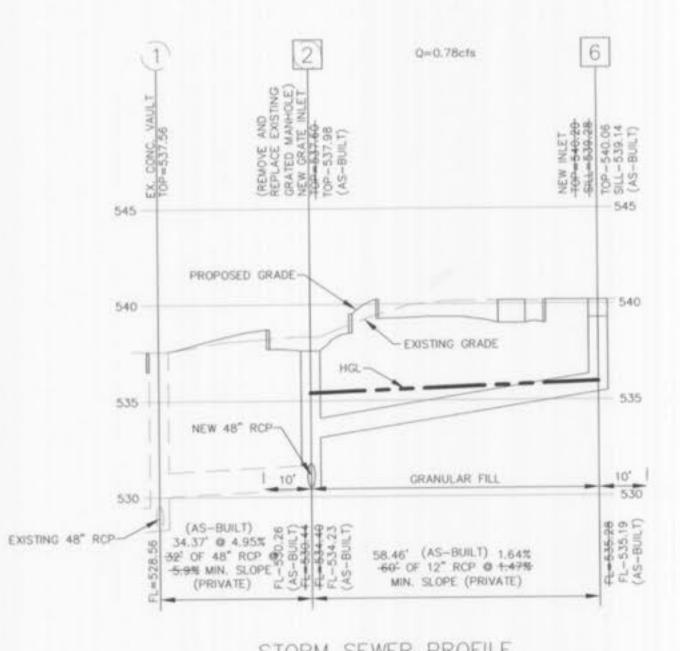

STORM SEWER PROFILE

HGL = HYDRAULIC GRADE LINE 1"=20' HORIZONTAL

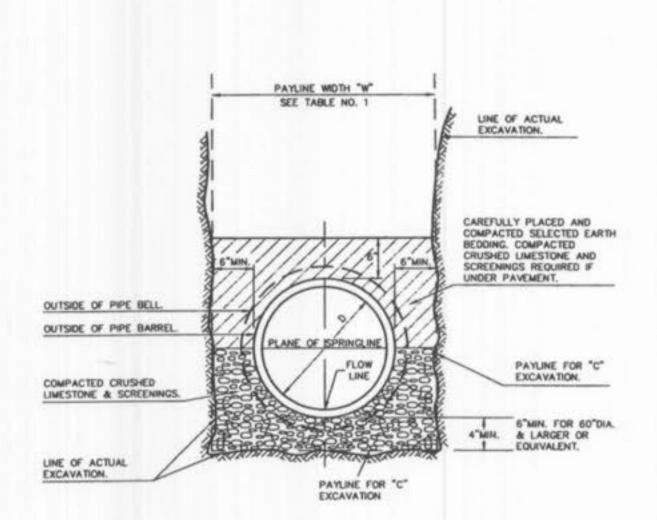

PIPE BEDDING CLASS "C" (MODIFIED FOR REINFORCED CONCRETE PIPE)

FINAL MEASUREMENT DRAWING

POEHLMAN & PROST, INC.



9330 BALBOA AVENUE SAN DIEGO, CA 92123

2 1999 Jack in the Box Inc These drawings and specification are the property of Jack in the Box Inc

and shall not be copied or reproduces without its previous written consent.

dates

RELEASE: DCT. 20, 2003

CONSTRUCTION: JULY 1, 2004

revisions

APRIL 30, 2004

APRIL 28, 2004

P.M.(JIB DNLY):

PERMIT

SEEDING RATES:

PERMANENT:

APPENDIX A

TALL FESCUE - 30 LBS./AC. SMOOTH BROME - 20 LBS/AC.

VEGETATIVE ESTABLISHMENT

FOR URBAN DEVELOPMENT SITES

COMBINED FESCUE @ 15 LBS/AC. AND BROME @ 10 LBS./AC.

TEMPORARY:

- 150 LBS./AC. (3.5 LBS. PER SQUARE FOOT) WHEAT OR RYE (2.75 LBS. PER SQUARE FOOT) - 120 LBS/AC. OATS

SEEDING PERIODS:

FESCUE OR BROME - MARCH 1 TO JUNE 1

AUGUST 1 TO OCTOBER 1

WHEAT OR RYE OATS

- MARCH 15 TO NOVEMEBER 1 - MARCH 15 TO SEPTEMBER 15

MULCH RATES: 100 LBS. PER 1,000 SQ. FEET (4,356 LBS. PER ACRE)

FERTILIZER RATES: NITROGEN 30 LBS./AC.

PHOSPHATE 30 LBS./AC. POTASSIUM 30 LBS./AC.

LIME 600 LBS./AC. ENM* *ENM = EFFECTIVE NEUTRALIZING MATERIAL AS PER STATE EVALUATION OF QUARRIED ROCK.

POEHLMAN & PROST, INC.	4-5-05		Revised: 4-28-05 (CONST 5-12-05 (CITY)
Land Surveying and Civil Engineering	DRAWN BY: S. SMITH	4-5-05	5-19-05 10-5-05 (ENTR
CO. Box 8340 280 Dielman Industrial Drive IL Louis, Missouri 63132	CHECKED BY: T. HAMILTON	0ATE 4-5-05	(ADDENDUM 2) 10-24-05(ENTR (ADDENDUM 3) 11-01-05
14) 997-5777 AX 997-0407 Mail: ppi@poehlman-prost.com	PROCFED #	DATE	12-13-05 AS-BUILTS
relect	orbin		7
JACK IN THE BOX #4047 O'FALLON, MISSOURI			
JACK IN THE BOX #4047	Sect. 10 - 2	6-06	Project Number: 204—169—


site information MK TYPE: 8ECBSQ44 JIB #: #4047/Q.S.#

ADDRESS:

415 S. MAIN

D' FALLON, MO DRAWN BY:

SEWER PROFILES AND DETAILS

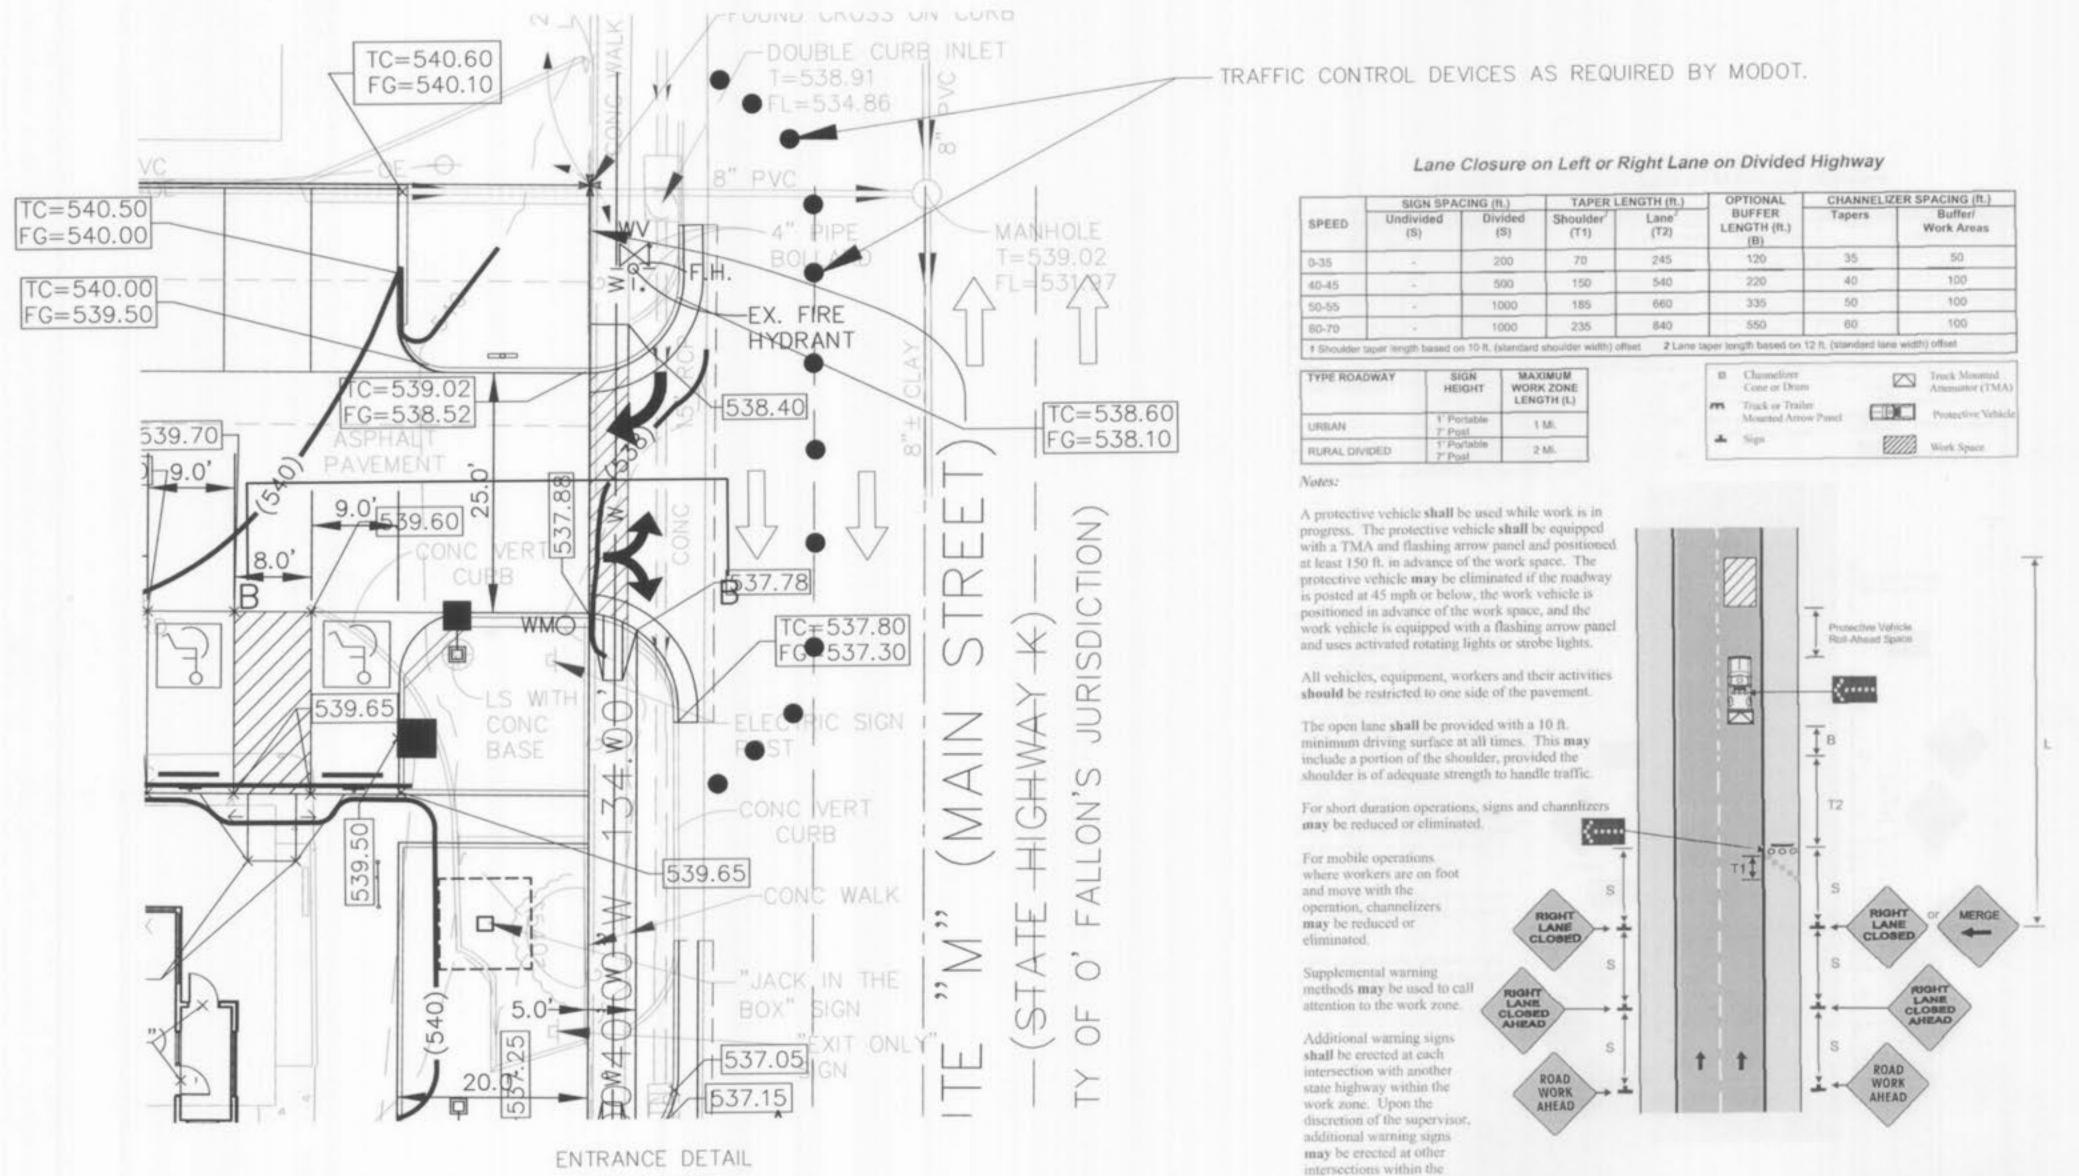

work zone.

TA-12