



**OPERATING FLOOR PLAN**  
Scale: 1/4" = 1'-0"

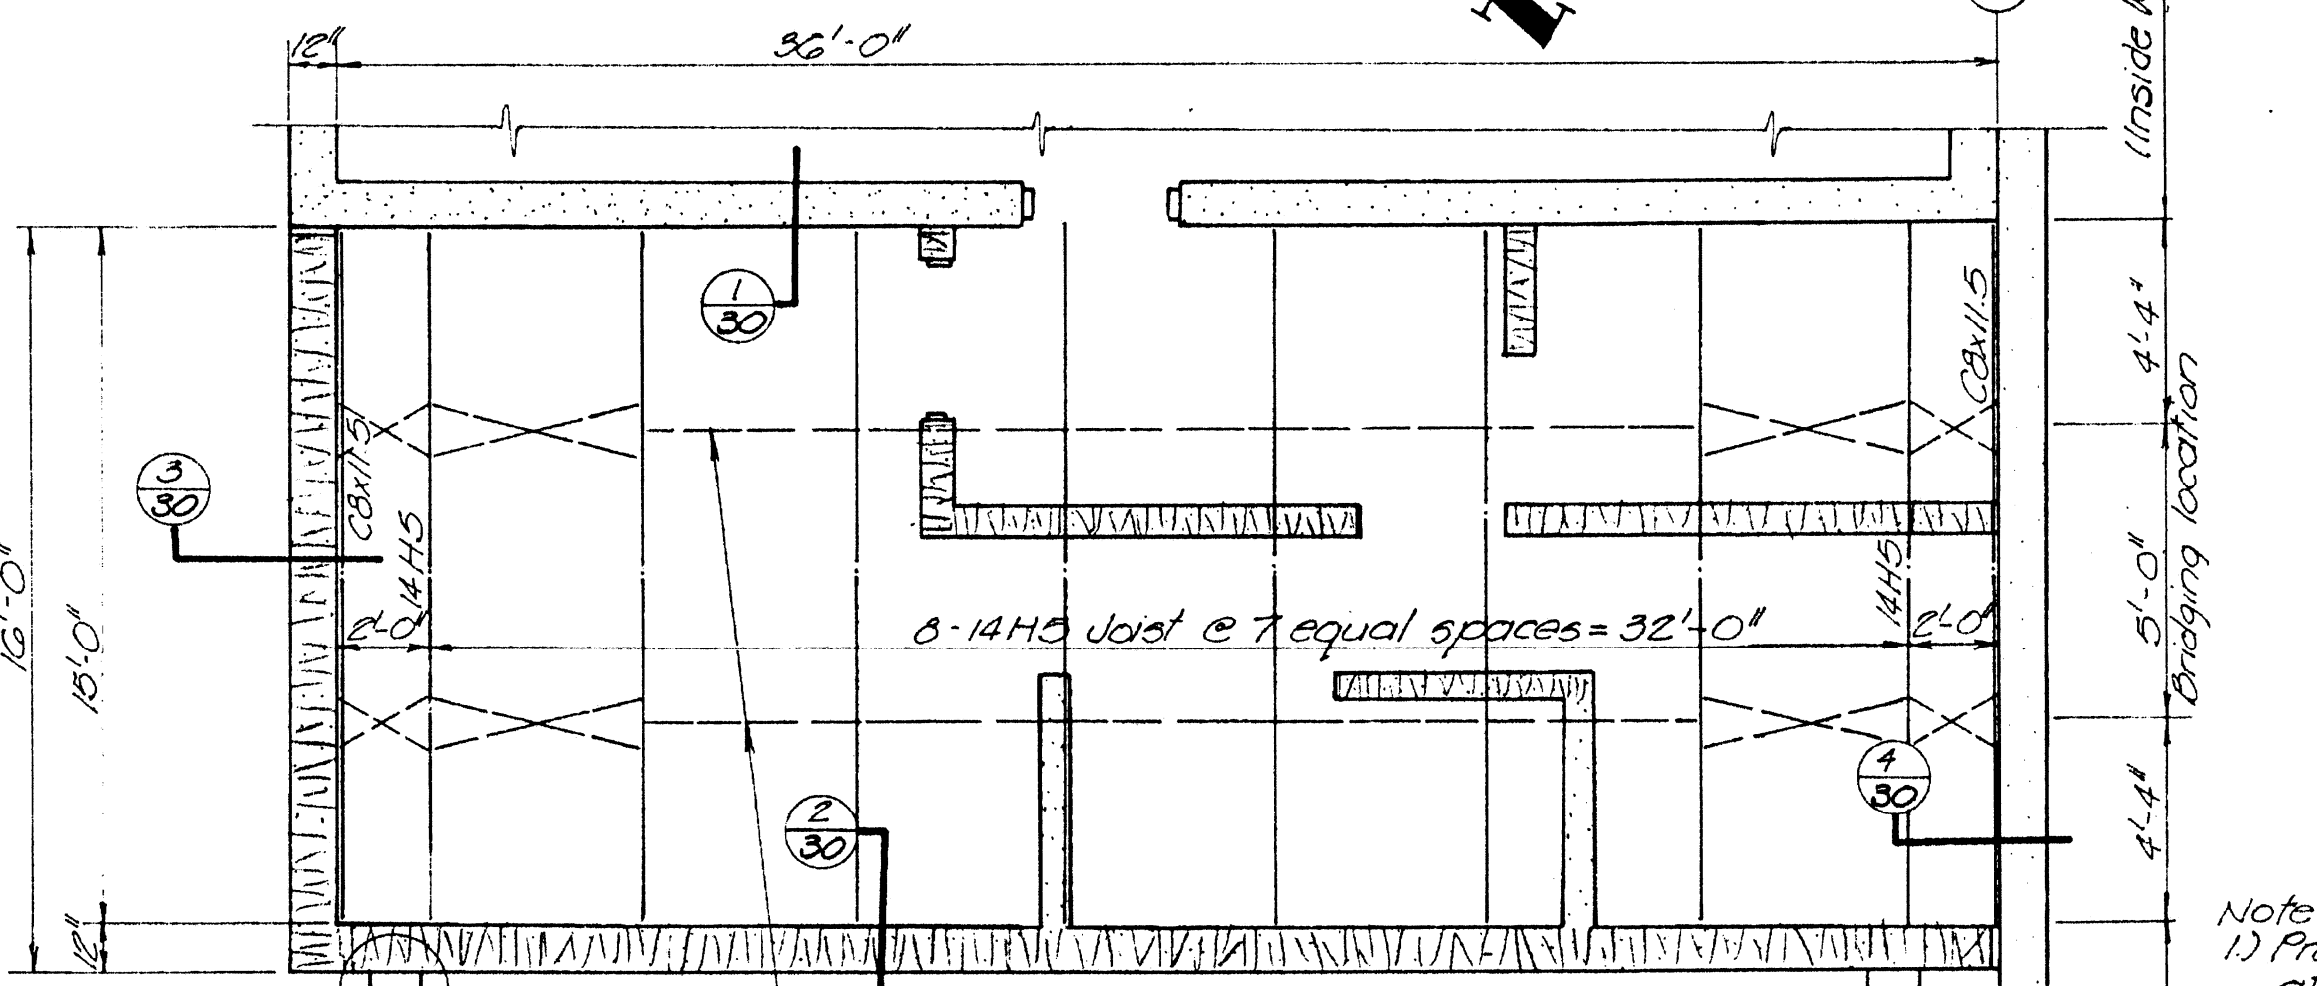


**OPERATING FLOOR - ROOF FRAMING PLAN**  
Scale: 1/4" = 1'-0"

Note:  
1) Provide bridging per Sull recommendations.  
2) Metal deck shall be 22ga. type A galvanized. The decking shall develop a design shear of 360 lbs. per lineal foot as a diaphragm and shall be welded in a 4x4 pattern as specified by Wheeling Corrugation Company.

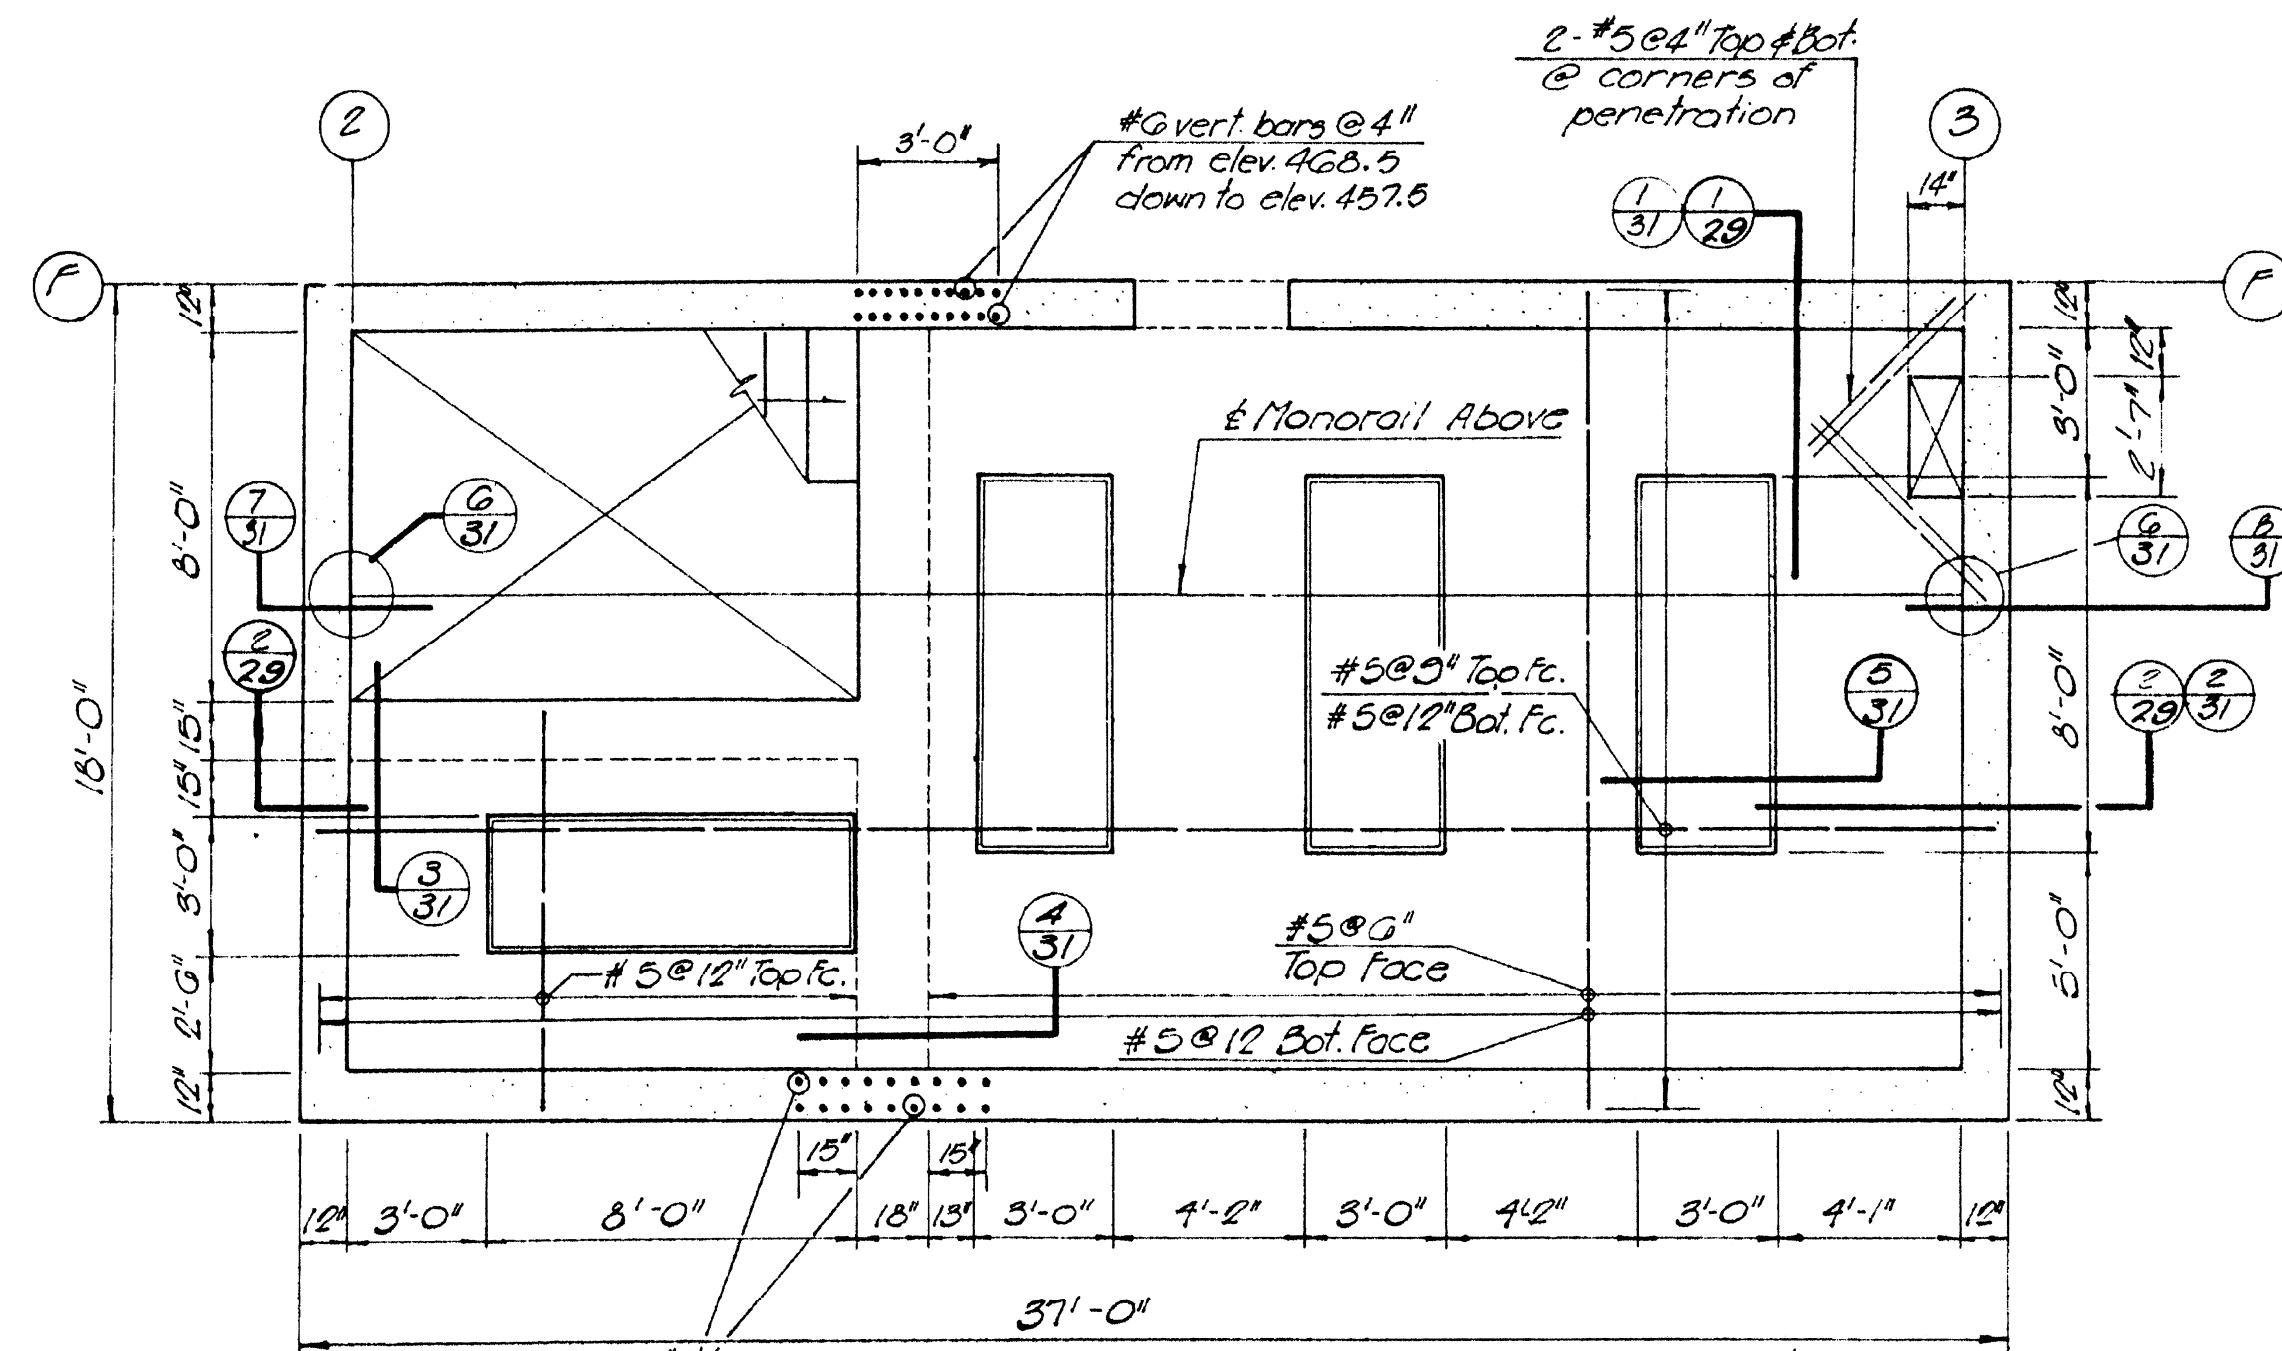

**BLOWER FLOOR - STRUCTURAL PLAN**  
Scale: 1/4" = 1'-0"

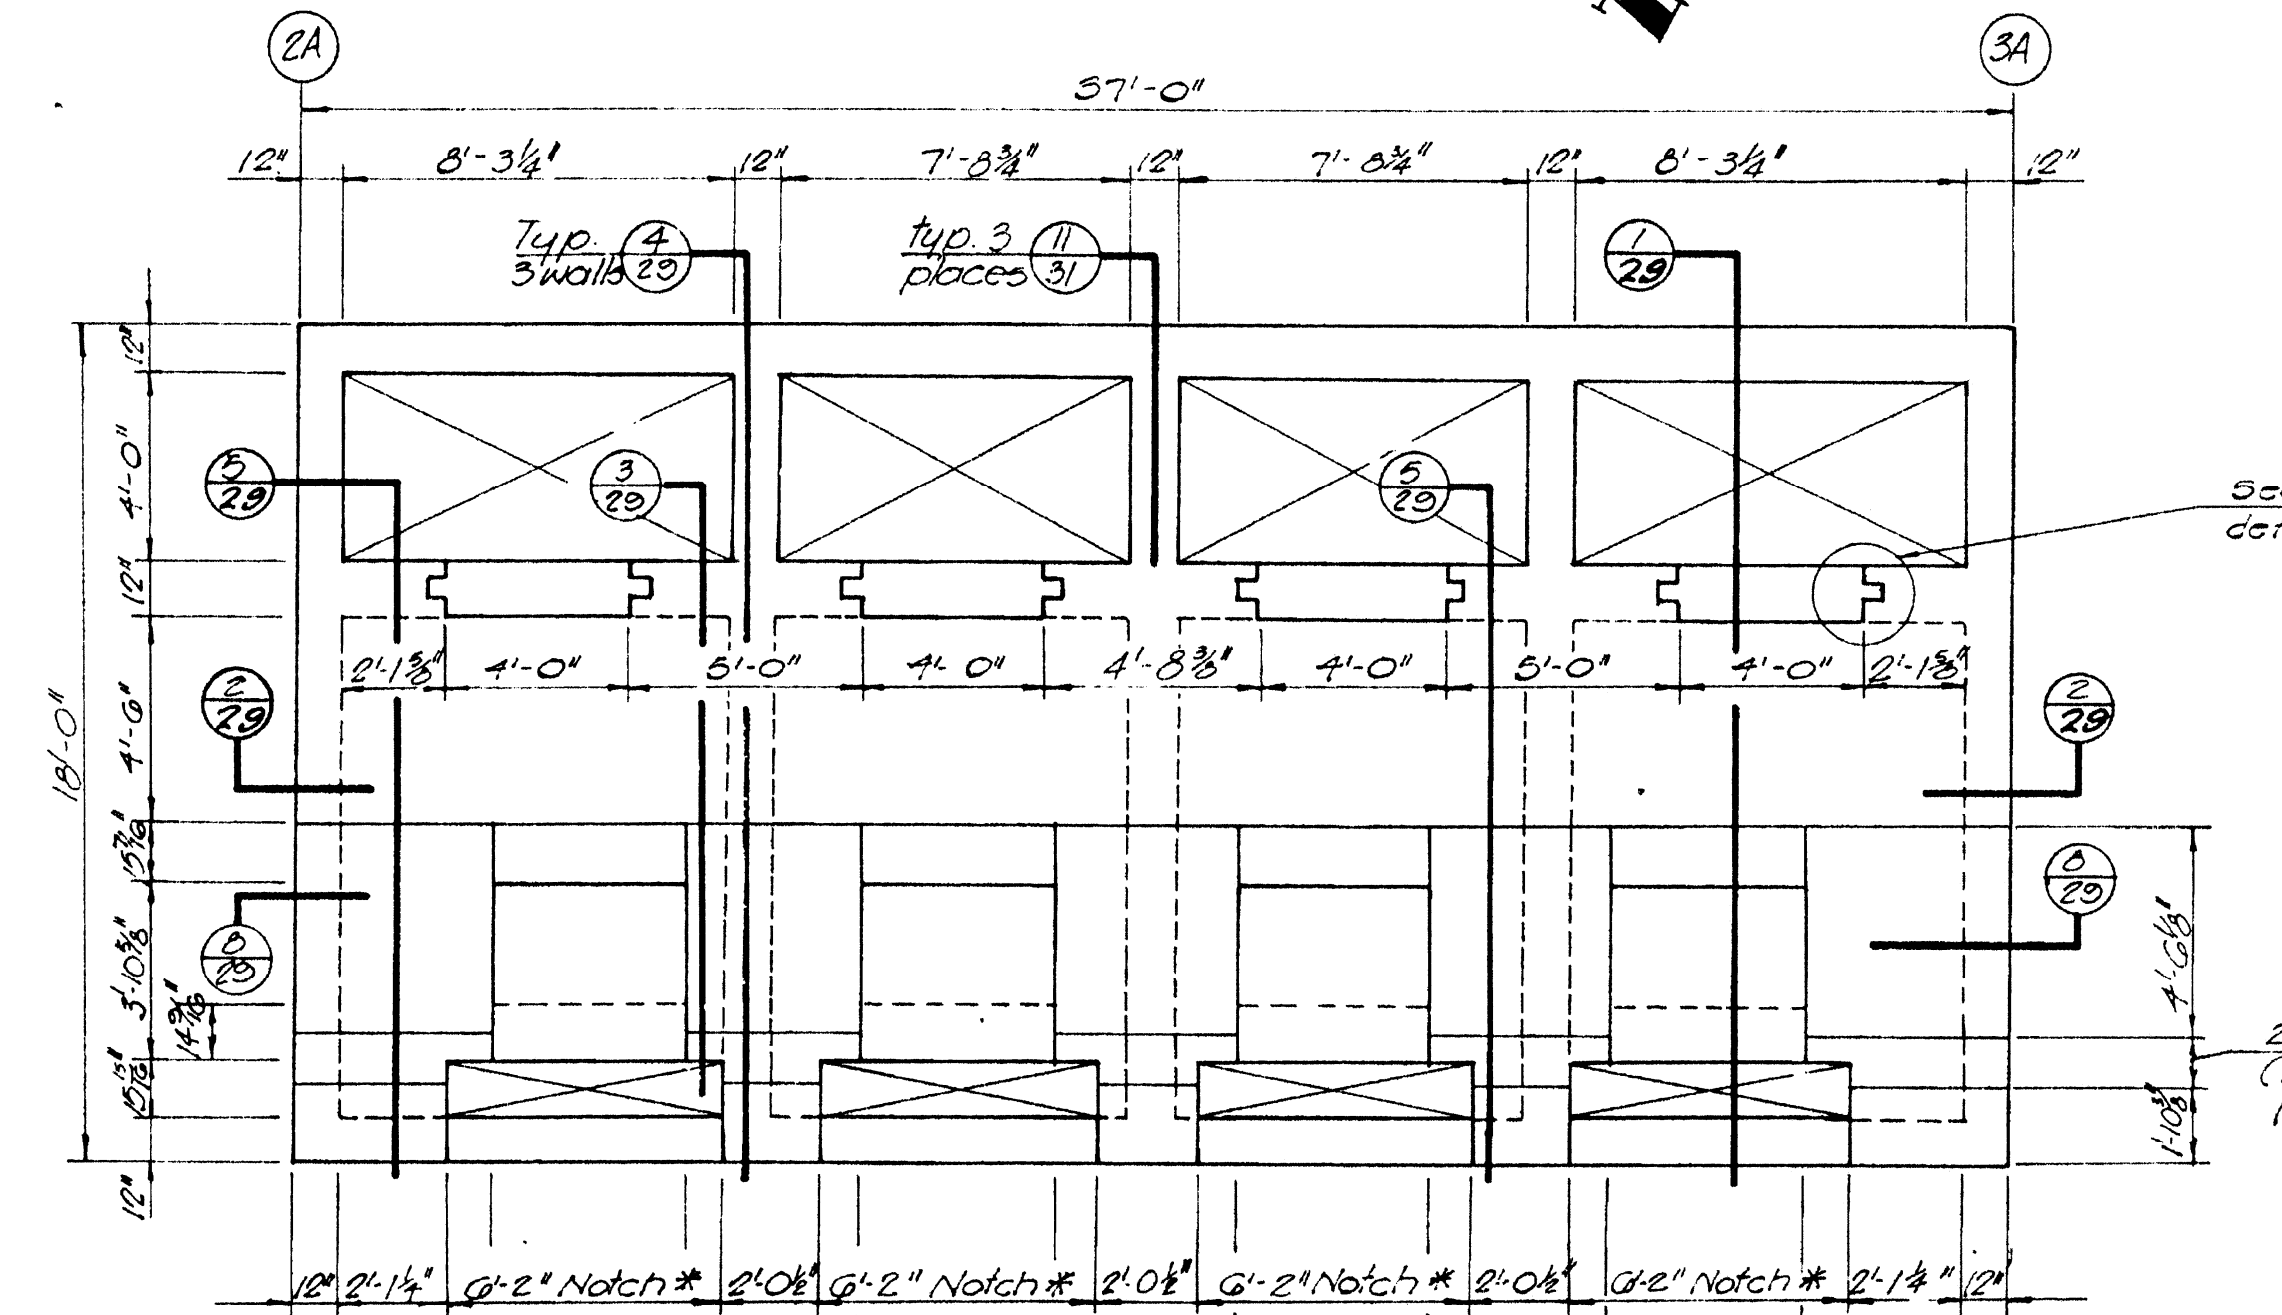

**UPPER LEVEL PLAN**  
Scale: 1/4" = 1'-0"

Notch on wall - depth to be determined by equip. purchased.

Revised 3/9/82 C.Raya  
E.P.A. PROJECT NO. C291090

**GBA**  
GEORGE BUTLER ASSOCIATES  
CONSULTING ENGINEERS/ARCHITECTS  
LANDSCAPE ARCHITECTS/PLANNERS

OFFICES:  
SUITE 305-A FAIRWAY OFFICE CENTER  
4210 JOHNSON DRIVE / SHAWNEE MISSION / KANSAS 66205  
1100 CITY CENTER SQUARE  
1100 MAIN / KANSAS CITY / MISSOURI 64105  
SUITE 134 LAKESIDE PLAZA II  
6700 CORPORATE DRIVE / KANSAS CITY / MISSOURI 64120

**WASTEWATER TREATMENT  
PLANT EXPANSION  
BIO-FILTER BUILDING  
STRUCTURAL FLOOR PLANS**

CITY OF FALLON, MISSOURI

DESIGNED BY J.S. DRAWN BY W.Y. CHECKED BY M.L.S.

JOB NO. 79-206B  
DATE July 30, 1981  
SCALE As noted  
SHEET NO. 27 OF 88