



- MODULE ELECTRICAL PANEL (ALL EQUIPMENT ON METAL FRAME SHALL BE PREWIRED AND TESTED. ELECTRICAL CONTRACTOR SHALL PROVIDE ONE ELECTRICAL CONNECTION TO MODULE ELECTRICAL PANEL.
- ALL EQUIPMENT AND PIPING INSTALLED ON STEEL PLATFORM OR PREFABRICATED
  WATER-SOURCE HEAT PUMP UTILITY MODULE SHALL BE SEISMIC RESTRAINT.
- (6) CHEMICAL POT FEEDER ON PLATFORM. SEE DETAIL M-1 FOR PIPING.
- (7) HORIZONTAL PRESSURE EXPANSION TANK. SEE DETAIL M-2 FOR PIPING.
- (8) BOUNDARY LINE OF PREFABRICATED WATER-SOURCE HEAT PUMP UTILITY MODULE.
- (9) REMOTE SUMP WITH WATER MAKE-UP VALVE ASSEMBLY. AND ANTI-VORTEXING NON-CORROSIVE PVC STRAINERS. SUMP SIZE 8'-11" 7/8Lx 4'-0"Wx 3'-8"H
- (10) 3" GAS LINE FROM BELOW. SEE FIRST FLOOR EAST WING PLAN FOR CONTINUATION.
- (11) 1" MAKE-UP WATER FROM BELOW, SEE FIRST FLOOR EAST WING PLAN FOR
- HUB DRAIN. 6" ABOVE PLATFORM. SEE FIRST FLOOR EAST WING PLUMBING PLAN FOR CONTINUATION.
- (13) FLOOR DRAIN. SEE FIRST FLOOR EAST WING PLUMBING PLAN FOR CONTINUATION.
- (14) 2" OPENING IN SUMP LID FOR CHEMICAL TREATMENT PLASTIC PIPING.
- (15) 3/4" TREADED COUPLING FOR CHEMICAL TREATMENT SYSTEM.
- (16) 12" FIELD INSTALLED FLUE FROM B-1 AND B-2 WITH WALL MOUNTED DRAFT INDUSER BY TJERLUND MODULE # HS-5 WITH VH1-10 ADAPTER.
- (17) 48 X 24 LOUVER 50% FREE AREA WITH SHEET METAL COLLAR AND MOTORIZED DAMPER. ONE LOUVER 12" ABOVE FLOOR, ONE LOUVER 12" BELOW CEILING. BOTH MOTORIZED DAMPERS SHALL BE INTERLOCKED WITH B-1, B-2 IN WINTER MODE AND WITH EF-7 IN SUMMER MODE.

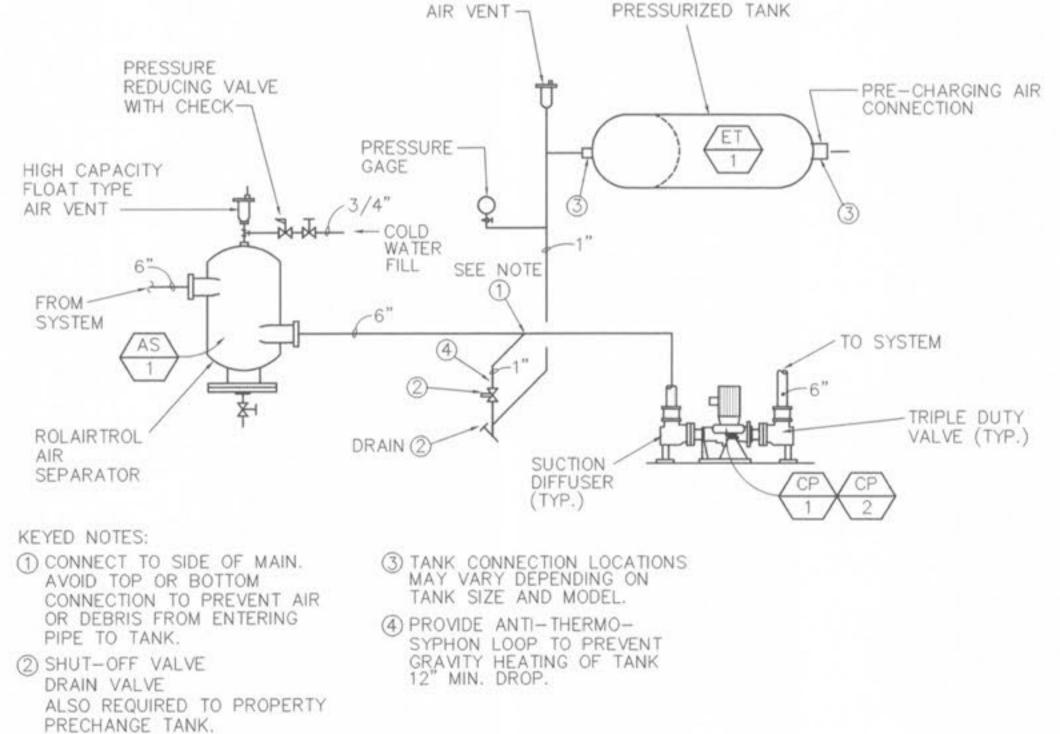

HORIZONTAL TANK INSTALLATION WITH ROLAIRTROL AIR SEPARATOR

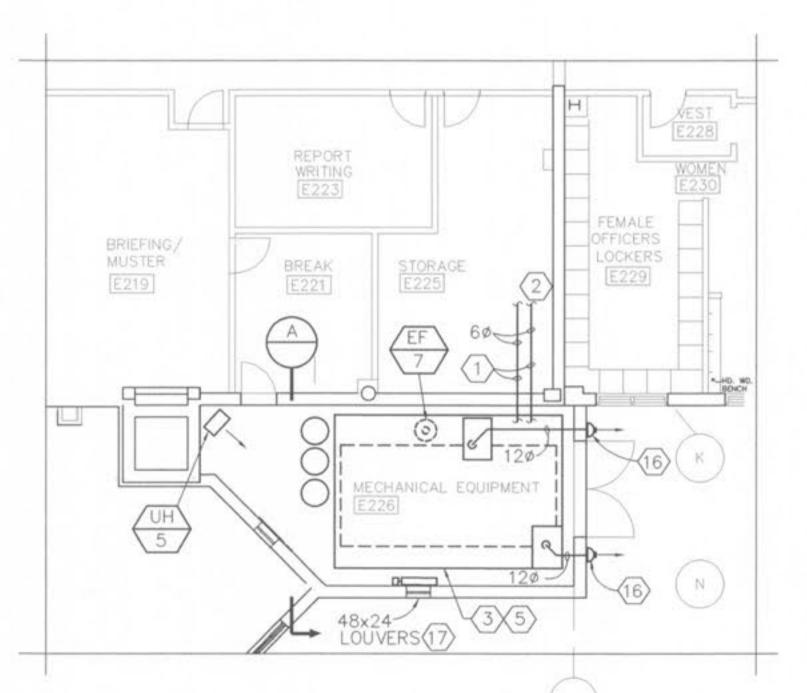

PARTIAL SECOND FLOOR PLAN-EAST WING SCALE: 1/8"=1'-0"

CONSTRUCTION Drawing No. **DOCUMENTS** 

Drawn MAG3 H-15

Date SEPT. 4, 1997

Project No.

Revisions

CONSTRUCTION ISSUE

**DECEMBER 5, 1997** 

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