#### ABBREVIATIONS

ELEVATION

ELEVATION

FACE OF CURB

EXISTING

EXISTING

FLOWLINE

GAS DRIP

GUARD POST

GRATED TROUGH

LIGHT STANDARD

MISCELLANEOUS

GWS/OWS GAS/OIL WARNING SIGN

HORIZONTAL

INVERT

IRON PIN

MANHOLE

MILLIMETER

EDGE OF PAVEMENT

FLARED END SECTION

RATE OF VERTICAL CURVE

MIDDLE ORDINATE AREA INLET ASPHALT NUMBER ASPH. NOT TO SCALE ADJUST TO GRADE BY OTHERS OF OUTFALL PULL BOX
POINT OF CURVATURE
PORTLAND CEMENT CONCRETE
PERMANENT DRAINAGE EASEMENT BACK OF CURB BEGINNING BLD. BM PRIVATE ENTRANCE POINT OF INTERSECTION BENCHMARK CENTERLINE POWER POLE COMMERCIAL ENTRANCE CHISELED PRIVATE SIGN CURB INLET POINT OF TANGENT
POINT OF VERTICAL CURVATURE
OR POLYVINYL CHLORIDE
POINT OF VERTICAL INTERSECTION CONSTRUCTION LIMIT CHAIN LINK FENCE CORRUGATED METAL PIPE CONC. CONST. PAVEMENT CONSTRUCTION/CONSTRUCT POINT OF VERTICAL TANGENT RADIUS CABLE SPLICE BOX RIGHT-OF-WAY COURT REINFORCED CONCRETE PIPE DOUBLE CURB INLET DRIVE

ROAD RETAINING RIGHT SIDEWALK SPECIAL GRATE INLET SHOULDER STREET SIGN STOPPING SIGHT DISTANCE


SURFACE TO BE ABANDONED
TO BE ADJUSTED
TEMPORARY BENCHMARK TBR&R TO BE REMOVED AND REPLACED TBR&RBO TO BE REMOVED AND REPLACED TEMPORARY CONSTRUCTION EASEMENT TEMPORARY TELEPHONE SPLICE BOX TRAFFIC LIGHT TYPICAL USE IN PLACE VERTICAL CURVE VITRIFIED CLAY PIPE WATER METER

STATION

# CITY OF O'FALLON

### DEPARTMENT OF PUBLIC WORKS

### CONSTRUCTION PLANS

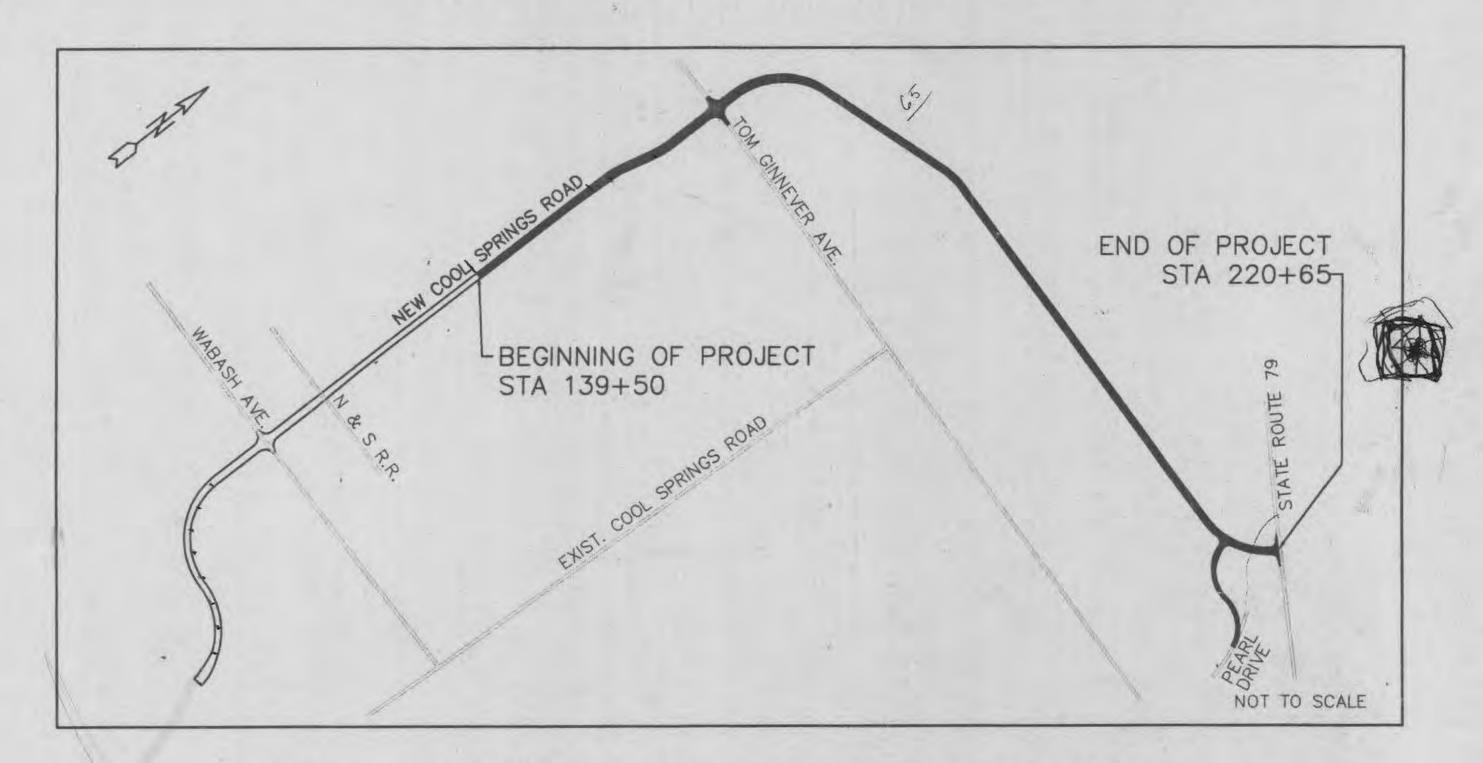

#### CONVENTIONAL SIGNS

XISTING	DESCRIPTION CONCRETE ASPHALT SOD LIGHT CONDUIT	PROPOSED
LS PP	PRESSURE SODIUM LUMINAIRE) POWER POLE	<del>- •</del>
SMH WMH SV	SEWER MANHOLE WATER MANHOLE SEWER VENT	
TH FH	FIRE HYDRANT INLET	¥
	GRATED INLET TREE DOUBLE INLET	3
GD, GV GWA	GAS DRIP, GAS VALVE GUY ANCHOR, WIRE WATER VALVE, WATER METER	Δ
	FENCE ELEVATION	-x-x-x-
	PROPERTY OR RIGHT-OF-WAY LINE CENTER OR SURVEY LINE SEWER PIPE	
	GAS PIPE WATER PIPE UNDERGROUND TELEPHONE	
	TEMPORARY CONSTRUCTION EASEMEN CONSTRUCTION LIMITS DITCH	

WHEEL CHAIR RAMP

### COOL SPRINGS ROAD EXTENSION

PLAN.....1"=50'

HORIZONTAL CONTROL FOR THIS PROJECT WAS ESTABLISHED BY ADOPTING CONTROL POINTS 6 & 10 FROM THE COOL SPRINGS ROAD/1-70 INTERCHANGE PLANS PREPARED BY BURNS & McDONNELL.

> POINT 6-80d WITH CROSS ON NORTH ASPHALT SCALES: SHOULDER OF EAST TERRA LANE AT GOLDEN TRIANGLE CONCRETE COMPANY. N 1081421.885 E 771275.0315

POINT 10-SET NAIL AT & DIAGONALS OF GRATE INLET AT ENTRANCE TO 84 LUMBER COMPANY. N 1081450.428

E 768816.4406

VERTICAL CONTROL FOR THIS PROJECT WAS ESTABLISHED BY ADOPTING BENCH MARK R-2 FROM THE COOL SPRINGS ROAD/1-70 INTERCHANGE PREPARED BY BURNS & McDONNELL.

R-2 CHISELED 'D' OUT 4 FEET EAST OF THE WALL AT EAST TERRA LANE BRIDGE. ELEV. 480.51

#### DISCLAIMER:

UNDERGROUND FACILITIES, STRUCTURES AND UTILITIES HAVE BEEN PLOTTED FROM AVAILABLE SURVEYS AND RECORDS AND, THEREFORE, THEIR LOCATIONS MUST BE CONSIDERED APPROXIMATE ONLY. THERE MAY BE OTHERS THE EXISTENCE OF WHICH IS AT PRESENT NOT KNOWN. VERIFICATION OF THE LOCATIONS OF UNDERGROUND UTILITIES, SHOWN OR NOT SHOWN, WILL BE THE RESPONSIBILITY OF THE CONTRACTOR.

### LENGTH OF PROJECT

PROFILE ......1"=50' HOR. & 1"=10' VER.

CROSS SECTION ..... 1"=10' HOR. & VER.

COOL SPRINGS ROAD

STA. 220+65 END OF PROJECT STA. 139+50 BEGINNING OF PROJECT

8,115 FEET APPARENT LENGTH O FEET EQUATIONS AND EXCEPTIONS TOTAL CORRECTIONS

NET LENGTH OF PROJECT



CONSTRUCTION OF STORM AND SANITARY SEWERS SHALL BE IN ACCORDANCE WITH THE 1992 METROPOLITAN ST. LOUIS SEWER DISTRIC SPECIFICATIONS FOR SEWERS AND DRAINAGE FACILITIES AND STANDARD CONSTRUCTION DETAILS.

## DESIGN DESIGNATION

received

A.D.T = 10,000 to 40,000 vpd (Estimated)

DESIGN SPEED = 40 mph (Cool Springs Road) DESIGN SPEED = 30 mph (Pearl Drive) DESIGN SPEED = 60 mph (Route 79)

#### INDEX OF SHEETS

SHEET NO.	DESCRIPTION	
1	COVER SHEET	
2-5	TYPICAL SECTIONS	
6-13	PLAN AND PROFILE-COOL SPRINGS ROAD	
14	PLAN AND PROFILE-PEARL DRIVE	
15	GEOMETRIC LAYOUT (WARPING)	
16-29	16-29 TRAFFIC CONTROL PLANS	
30-33 TEMPORARY EROSION CONTROL PLA		
34-39	STRIPING AND SIGNAGE PLANS	
40-46	SIGNAL PLANS	
47-57	PIPE PROFILES	
57	BOX CULVERT PROFILES	
58	BOX CULVERT STRUCTURAL DETAILS	
59-91	CROSS SECTIONS-COOL SPRINGS ROAD	
92-96	CROSS SECTIONS-PEARL DRIVE	
97-105	CROSS SECTIONS-STATE ROUTE 79	
106-107	DRIVEWAY PROFILES	
	$\gamma$	

