

FIRE PROTECTION DESIGN CRITERIA
 TOTAL AREA SHALL BE PROTECTED BY A WET-PIPE SPRINKLER SYSTEM. SPRINKLER HEADS SHALL BE OF A TYPE DESIGNED PER NFPA 13 REQUIREMENT LIGHT HAZARD OCCUPANCY, 0.10 GPM PER SQUARE FOOT OVER THE MOST REMOTE 1500 SQUARE FEET, PLUS 100 GPM HOSE STREAM DEMAND AND 225 SQUARE FOOT PER HEAD SPACING, 1/2" ORIFICE AND 180 DEGREE HEAD.

NOTES:

1. ALL PIPING AND BRACING TO MEET ALL BUILDING CODE REQUIREMENTS.
2. CONTRACTOR SHALL COORDINATE EXACT LOCATION OF SPRINKLERS WITH DIFFUSERS, DUCTWORK, LIGHTS AND ALL OTHER TRADES.
3. REFER TO ARCH. REFLECTED CEILING PLANS.
4. SPRINKLER HEADS IN AREAS WITH CEILINGS SHALL BE CONCEALED AUTOMATIC SPRINKLERS.
5. SPRINKLER HEADS IN AREAS WITH NO CEILINGS SHALL BE BRONZE UPRIGHT OR PENDENT AUTOMATIC SPRINKLERS. IN THE GYMNASIUM SPRINKLER HEADS SHALL HAVE WIRE GUARDS.

NOTES:


1. FOR SYMBOLS, ABBREVIATIONS AND GENERAL NOTES, SEE DRAWING FP001.

Revision: Date: By: Description:
 12/9/02 FJP ISSUED FOR BD



RENAUD SPIRIT CENTER


For the City of O'Fallon - Missouri

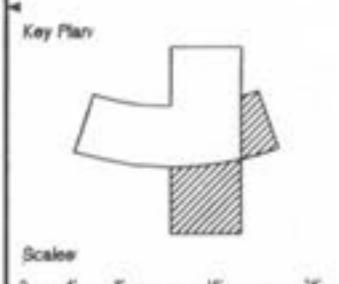

Jacobs Project No: P3W40600
 Drawing Title:

FIRE PROTECTION
 MEZZANINE PLAN
 SOUTH-EAST

Date: DECEMBER 9, 2002
 Designed By: FJP Drawing No:
 Drawn By: FJP
 Checked By: LANGENFELD | FP304

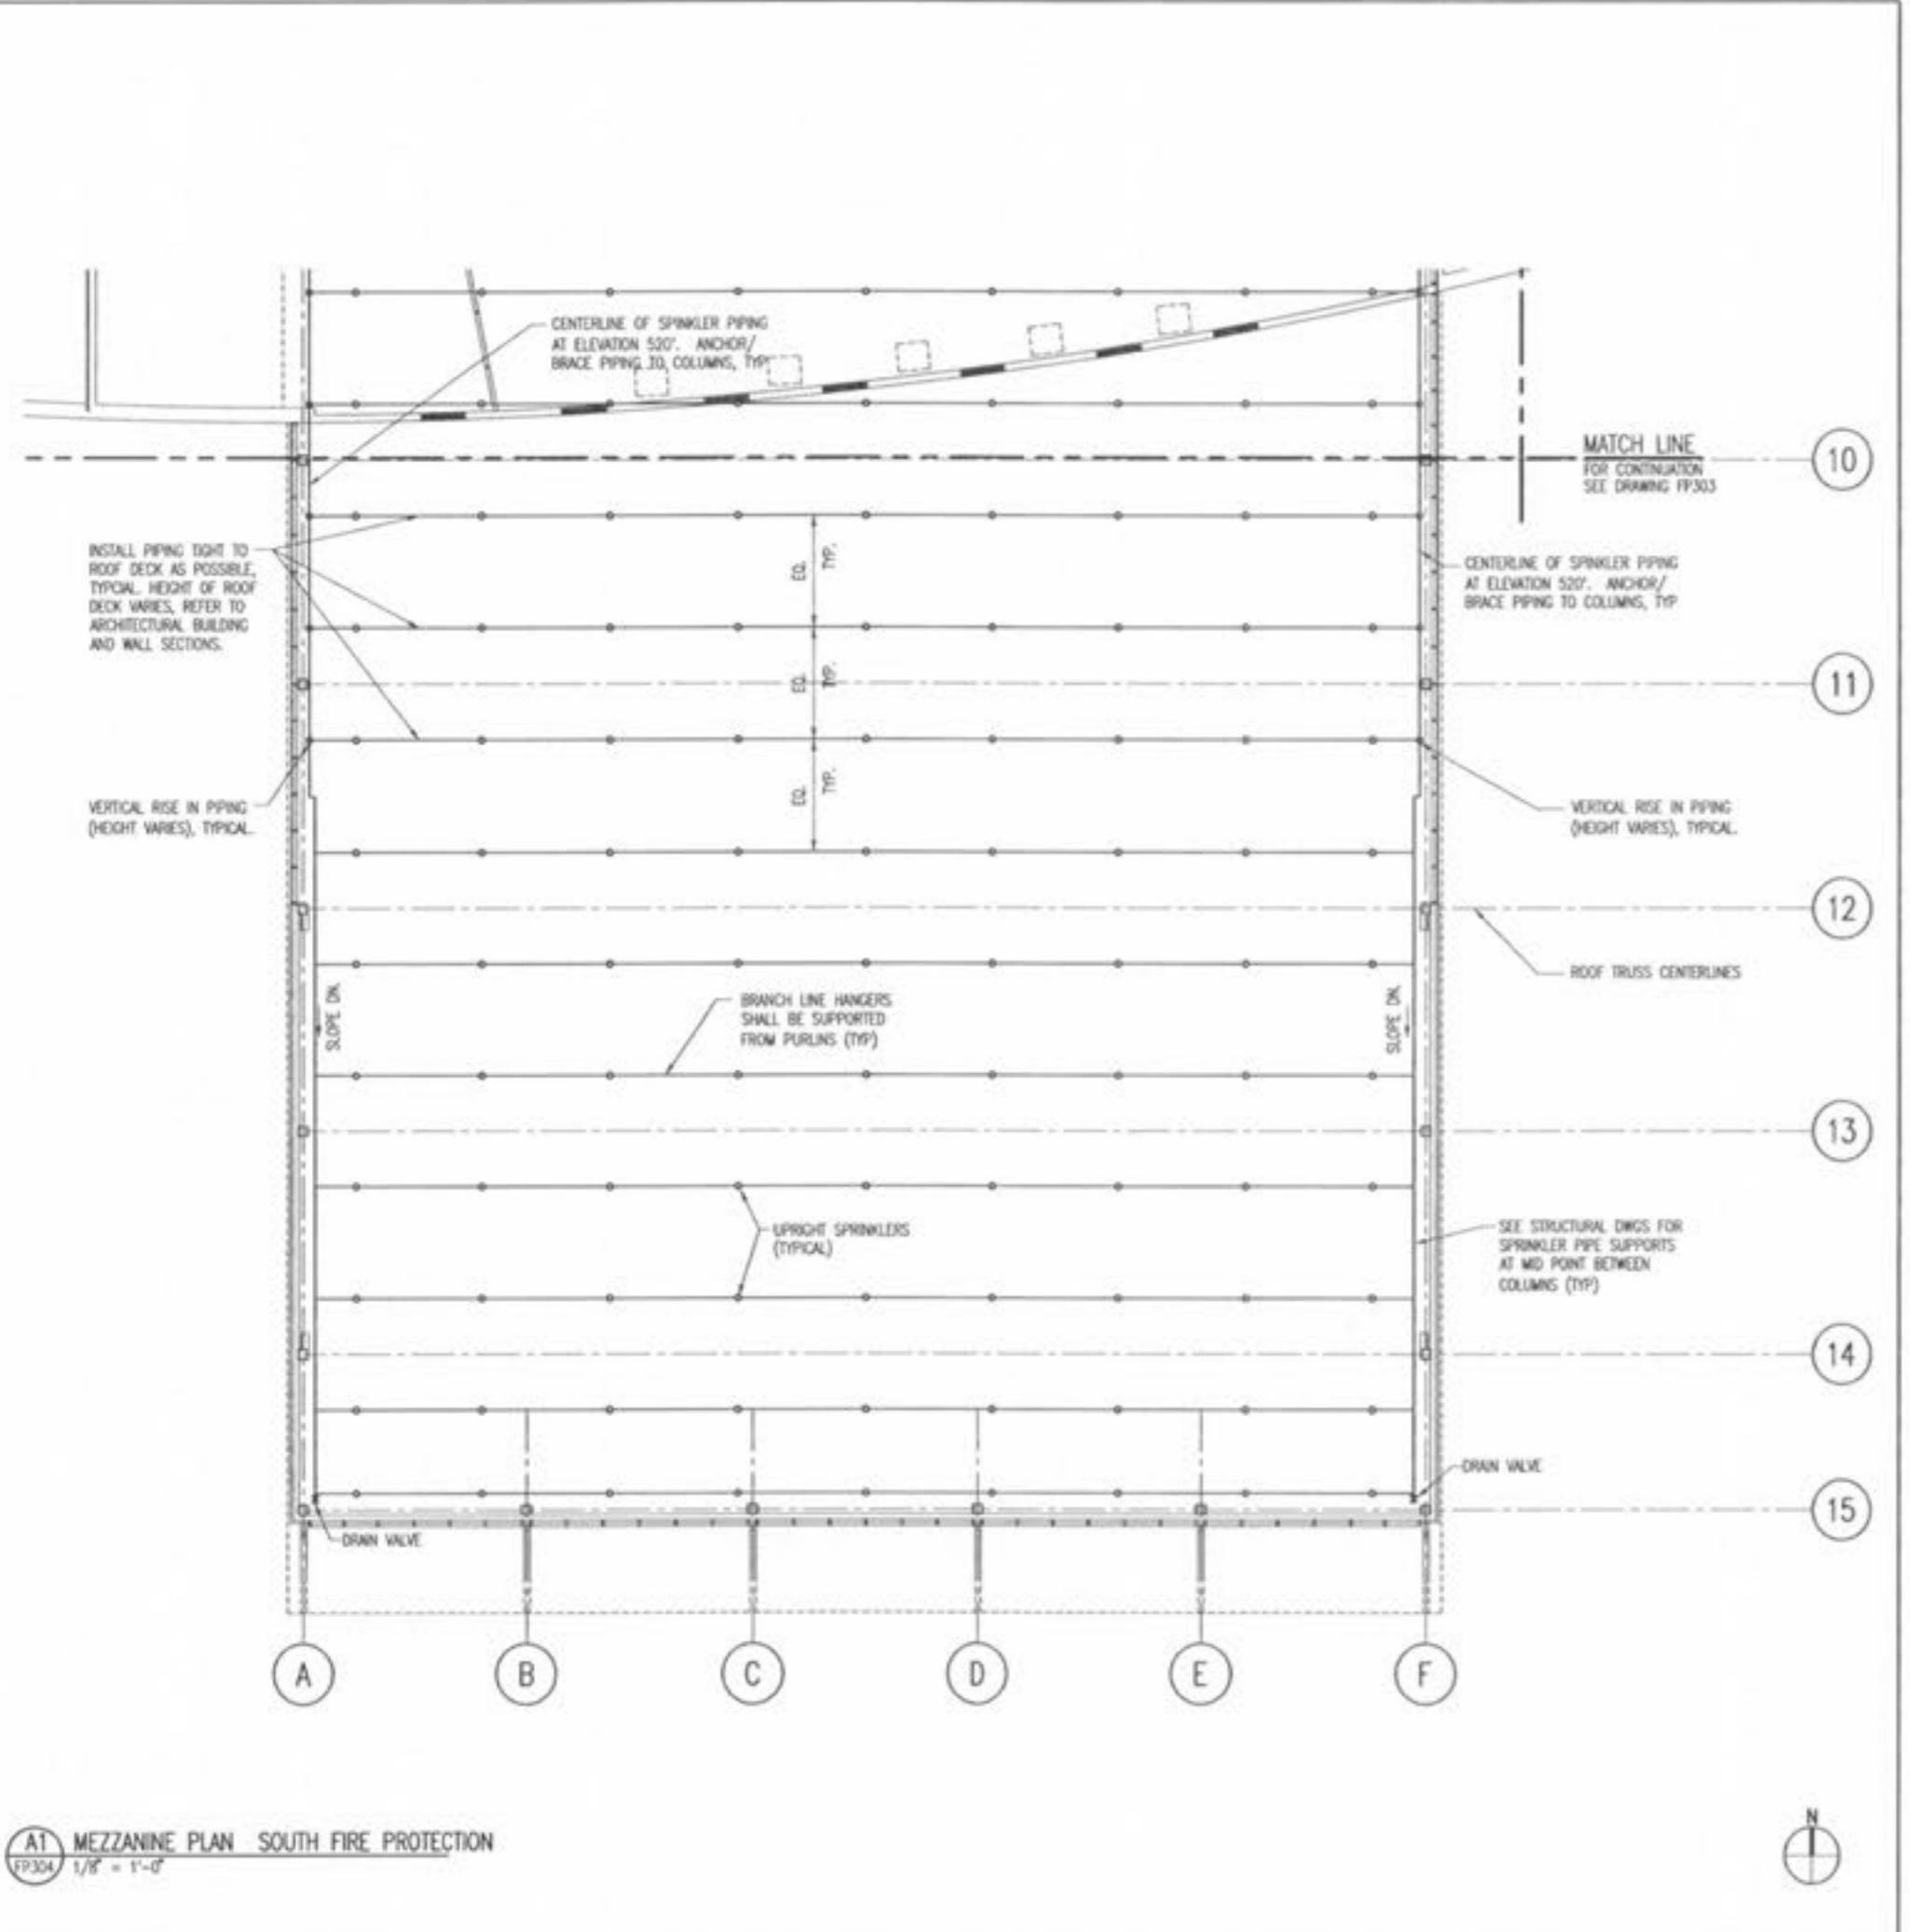

(A1) MEZZANINE PLAN SOUTH FIRE PROTECTION
 FP304 1/8" = 1'-0"