

ST. CHARLES TOWER

MEXICO & SONDEREN - MO2014-19

NEW SITE BUILD 8368 MEXICO RD. O'FALLON, MO 63366 ST. CHARLES COUNTY

S/H PROJECT # 8156607

NEW MONOPOLE

clients/contractors responsibility to verify the location of all utilities (whether shown or not) and protect sold utilities from any damage. **GPS COORDINATES**

ATITUDE: ONGITUDE.

N38 47 32.78 W90' 41' 26.47"

ELEVATION AT GRADE:

SITE BENCHMARK: TOP OF WATER VALVE, ELEV.=537.45"

530

LOCAL JURISDICTION INFO

JURISDICTION

CITY OF O'FALLON

C-2 (GENERAL BUSINESS)

EXISTING TOWER X RAWLAND

EXISTING WATER TOWER COTHER


FLOODELAIN INFORMATION

JEXISTING BUILDING

THIS TRACT IS LOCATED WITHIN ZONE "X", AREA DETERMINED TO BE OUTSIDE THE 500-YEAR FLOODPLAIN, AS LOCATED ON FIRM MAP NO. 29183C0237 E, DATED AUGUST 2, 1996

PROFESSIONAL CERTIFICATION

SHIVE HATTERY INC ARCHITECTURE CERTIFICATION NUMBER: 2005027658 SHIVE-HATTERY, INC ENGINEERING CERTIFICATION NUMBER: 2004032498

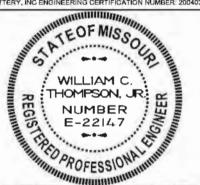

WILLIAM C. THOMPSON, IR, REGISTERED PROFESSIONAL ENGINEER REGISTRATION NUMBER: E-22147



REGISTRATION NUMBER: 2007005050

PROJECT DESCRIPTION

- PROPOSED ST. CHARLES (MONOPOLE) INSTALLED WITHIN A NEW LEASE AREA. EASEMENTS, AND VINYL FENCED COMPOUND
- PROPOSED SITE GRADING, NEW CONCRETE APRON, ASPHALT DRIVE & EROSION CONTROL MEASURES PER CITY OF O'FALLON SPECIFICATIONS SHOWN HEREIN.
- PROPOSED POWER / SITE GROUNDING



DRIVING DIRECTIONS

ROM THE ST. CHARLES TOWER INC. OFFICE IN CHESTERFIELD DRIVE ON WEST DR SOUTH) 0.3 MI TURN RIGHT (WEST) ONTO MO-340 [OLIVE BLVD] FOR 0.7 MI. TURN RIGHT (WEST) ONTO N OUTER FORTY RD [N OUTER 40] FOR 0.4 MI. TAKE RAMP (LEFT) ONTO I-64 [US-40] FOR 8.9 MI. AT EXIT 9, TURN RIGHT ONTO RAMP FOR 0.3 MI. MO-K / O'FALLON KEEP RIGHT TO STAY ON RAMP FOR 0.3 MI. MO-K / O'FALLON TURN RIGHT (NORTH) ONTO SR-K. FOR 5.6 MI TURN RIGHT (EAST) ONTO MEXICO RD FOR 0.4 MI. TURN LEFT (NORTH) ONTO SONDEREN EXT. FOR 98 YDS. TURN RIGHT

CONTRACTOR SHALL VERIFY PLANS AND EXISTING DIMENSIONS AND CONDITIONS ON THI JOB SITE AND SHALL IMMEDIATELY NOTIFY THE ARCHITECT IN WRITING OF DISCREPANCIES BEFORE PROCEEDING WITH THE WORK OR BE RESPONSIBLE FOR SAME.

PROJECT SUMMARY

SITE NUMBER SITE NAME-

MO2014-19 MEXICO & SONDEREN

SITE ADDRESS:

8368 MEXICO ROAD O'FALLON, MO 63366 ST. CHARLES COUNTY

CURRENT ZONING:

C-2 (GENERAL BUSINESS) T082500003

PARCEL NUMBER PROPERTY OWNER: PROPERTY CONTACT

GREYSTONE HOLDINGS LLC 3555 HWY F DEFIANCE MO, 63341

OWER OWNER

ST. CHARLES TOWER #4 WEST DR. SUITE 110 CHESTERFIELD, MO 63017 (636) 530-9824

APPLICANT:

ST. CHARLES TOWER #4 WEST DR. SUITE 110 CHESTERRIELD, MO 63017 MICHELLE DOHRMAN (636) 230-9824

A/E FIRM:

SHIVE-HATTERY 3025 HIGHLAND PKWY, DOWNERS GROVE, IL 60515 (630) 390-7444 JEFF PFAFF

UTILITIES

ELECTRICAL UTILITY

AMEREN 800-552-7583 CENTURY LINK

636-332-3011

TELCO UTILITY

CODE COMPLIANCE

WORK SHALL BE PERFORMED AND MATERIALS INSTALLED IN ACCORDANCE WITH THE CURRENT EDITIONS OF THE FOLLOWING CODES AS ADOPTED BY THE CITY OF O'FALLON OCAL GOVERNING AUTHORITIES, NOTHING IN THESE PLANS TO BE CONSTRUED TO PERMIT WORK NOT CONFORMING

BUILDING CODE: IBC 2009 W/ AMENDMENTS RESIDENTIAL CODE: IRC 2009 W/ AMENDMENTS PLUMBING CODE: IPC 2009 W/ AMENDMENTS MECHANICAL CODE: IMC 2009 W/ AMENDMENTS ELECTRICAL CODE: NEC 2008 W/ AMENDMENTS FIRE CODE: IFC 2009 W/ AMENDMENTS TIA/EIA-222G OR LATEST EDITION

REQUIREMENTS OF APPROVAL

1. IN ACCORDANCE WITH SECTION 400.870 B. 2., THE PETITIONER SHALL STATE THAT AN ANALYSIS WAS CONDUCTED ON ANY FACILITIES WITHIN A ONE (1) MILE RADIUS, AND PROVIDE AN EXPLANATION TO WHY COLOCATION WAS NOT POSSIBLE.

CONSTRUCTION HOURS:

CITY OF O'FALLON CONSTRUCTION WORKING HOURS PER ORDINANCE 3429 IN SECTION 500.420 OF THE CITY OF O'FALLON MUNICIPAL CODE.

OCTOBER 1 - MAY 31:

7:00 A.M. TO 7:00 P.M. MONDAY - SUNDAY

JUNE 1 - SEPTEMBER 30:

6:00 A.M. TO 8:00 P.M. MONDAY - FRIDAY 7:00 A.M. TO 8:00 P.M. SATURDAY AND SUNDAY CONSTRUCTION WORK TO BE DONE OUTSIDE OF THESE HOURS REQUIRES PRIOR WRITTEN APPROVAL FROM THE CITY ADMINISTRATOR OR CITY ENGINEER

	ET INDEX		
SHT.	DESCRIPTION	REV NO.	
T-1	TITLE SHEET	3	
N-1	GENERAL NOTES	3	
N-2	GENERAL NOTES	3	
N-3	GENERAL NOTES	3	
N-4	ELECTRICAL NOTES	3	
N-5	GROUNDING NOTES	3	
N-6	SYMBOLS & ABBREVIATIONS	3	
SUV-1	PARTIAL BOUNDARY TOPOGRAPHIC & IMPROVEMENT SURVEY (BY OTHERS)	3	
C-1	COMMERCIAL DRIVE DETAILS	3	
C-2	COMMERCIAL DRIVE DETAILS	3	
C-3	COMMERCIAL DRIVE DETAILS	3	
C-4	COMMERCIAL DRIVE DETAILS	3	
C-5	SILT FENCE INSTALLATION	3	
C-6	CHECK DAMS	3	
C-7	CHECK DAMS	3	
C-8	CURB INLET PROTECTION	3	
C-9	SPACING CHART FOR ESC DEVICES	3	
C-10	GENERAL NOTES	3	
C-11	GENERAL NOTES	3	
A-1	SITE PLAN	3	
A-2.1	COMPOUND PLAN	3	
A-2.2	SITE GRADING PLAN	3	
A-2.3	LANDSCAPING PLAN AND DETAILS	3	
A-2.4	ENTRANCE DETAIL	3	
A-2.5	ELEVATION	3	
A-3	SITE WORK DETAILS	3	
A-4	FENCE DETAILS	3	
A-5	UTILITY RACK DETAILS	3	
E −1	UTILITY PARTIAL SITE PLAN	3	
E-2	UTILITY SERVICE ENTRANCE SCHEMATIC	3	
E-3	COMPOUND GROUNDING PLAN	3	
E-4	GROUNDING RISER	3	
E-5	GROUNDING DETAILS	3	

PLANNING AND DEVELOPMENT DIVISION FILE NUMBER: 1302.14 DATED MAY 28, 2015 [T]

PROJECT NO: 8156607 CHECKED BY: JMD 0 8/5/15 CLIENT REVIEW 1 9/23/15 BID/PERMIT 2 11/02/15 CITY COMMENTS 3 11/24/15 ENG REVIEW

> MEXICO & SONDEREN

SITE# MO-2014-19

8368 MEXICO ROAD O'FALLON, MO 63366 ST. CHARLES COUNTY MONOPOLE

SHEET TITLE TITLE SHEET

SHEET NUMBER

-1

- 1. THE EXISTING TOPOGRAPHY AND VERTICAL GEOMETRY REPRESENTED ON THESE DRAWINGS IS TO BE VERIFIED BY CONTRACTOR. CONTRACTOR SHALL CONTACT UTILITY LOCATE SERVICES A MINIMUM OF 72 HOURS PRIOR TO THE START OF CONSTRUCTION TO IDENTIFY THE EXISTENCE AND LOCATION OF UNDERGROUND AND OVERHEAD UTILITIES AND SERVICES. CONTRACTOR IS TO IMMEDIATELY NOTIFY ENGINEER OF DISCREPANCIES OR INTERFERENCE THAT WILL AFFECT THIS PROJECT. EXISTING UTILITIES SHALL BE PROTECTED AND REPAIRED THE CONTRACTOR'S EXPENSE IF DAMAGED. EXTREME CAUTION SHOULD BE USED BY THE CONTRACTOR WHEN EXCAVATING OR PIER DRILLING AROUND OR NEAR UTILITIES. CONTRACTOR SHALL PROVIDE SAFETY TRAINING FOR THE WORKING CREW.
- 2. DAMAGE TO THE EXISTING FACILITY SHALL BE REPAIRED OR REPLACED TO MATCH EXISTING ORIGINAL CONDITIONS AT THE CONTRACTOR'S EXPENSE.
- 3. EXISTING INACTIVE UTILITIES WHICH PROHIBIT CONSTRUCTION SHALL BE REMOVED, CAPPED, PLUGGED OR OTHERWISE DISCONTINUED AS REQUIRED TO ALLOW CONSTRUCTION TO CONTINUE. COORDINATE WITH PROJECT MANAGER, OWNER, AND/OR LOCAL UTILITY COMPANIES FOR APPROVAL.
- 4. CONTRACTOR SHALL NOTIFY THE PROPERTY OWNER OF THE CONSTRUCTION START WELL IN ADVANCE (MIN. 1 WEEK) OF THE CONSTRUCTION DATE.
- INFORMATION ON TOWER STRUCTURE, FOUNDATIONS, EQUIPMENT, AND/OR SHELTER SHALL BE PROVIDED BY OTHERS.
- A 20' HORIZONTAL CLEARANCE SHALL BE MAINTAINED FROM EXISTING POWER LINES TO PROPOSED TOWER COMPOUND.
- SURVEY INFORMATION REFERENCED IN THESE DRAWINGS COMPLIES WITH FAA ORDER 8260.19D ACCURACY TOLERANCES.
- 8. PROVIDE LABOR, MATERIAL, TOOLS, EQUIPMENT, TRANSPORTATION AND TEMPORARY POWER SERVICES NECESSARY FOR AND INCIDENTAL TO COMPLETION OF WORK AS INDICATED ON THE DRAWINGS AND/OR AS SPECIFIED HEREIN.
- 9. THE ORAWINGS ARE DIAGRAMMATIC AND INDICATE THE GENERAL ARRANGEMENT OF SYSTEMS AND EQUIPMENT UNLESS OTHERWISE INDICATED BY DIMENSIONS OR DETAILS. EXACT EQUIPMENT LOCATIONS SHALL BE GOVERNED BY ACTUAL FIELD CONDITIONS AND/OR INSTRUCTIONS OF THE ENGINEER AND/OR TOWER OWNER'S REPRESENTATIVE.
- 10. THE CONTRACTOR SHALL FURNISH AND INSTALL MATERIALS AS REQUIRED FOR COMPLETE SYSTEMS, INCLUDING PARTS OBVIOUSLY OR REASONABLY INCIDENTAL TO A COMPLETE INSTALLATION, WHETHER SPECIFICALLY INDICATED OR NOT. SYSTEMS SHALL BE COMPLETELY ASSEMBLED, TESTED, ADJUSTED AND DEMONSTRATED TO BE READY FOR OPERATION PRIOR TO OWNER'S ACCEPTANCE.
- 11. THE CONTRACTOR SHALL OBTAIN, PAY FOR AND OELIVER REQUIRED PERMITS, CERTIFICATES OF INSPECTION, INCLUDING UTILITY CONNECTION FEES, ETC., REQUIRED BY THE AUTHORITIES HAVING JURISDICTION. DELIVER CERTIFICATES TO THE OWNER PRIOR TO FINAL ACCEPTANCE OF THE WORK.
- 12. THE CONTRACTOR SHALL MAINTAIN BENCHMARKS, CONSTRUCTION STAKING, AND OTHER ELEVATION CONTROL POINTS AND SHALL REESTABLISH, IF DISTURBED OR DESTROYED, AT NO ADDITIONAL COST TO THE OWNER.
- 13. THE CONTRACTOR SHALL BE RESPONSIBLE FOR REPAIR AND OR RESTORATION OF DAMAGE TO THE EXISTING ACCESS ROADWAY AND ADJACENT SITE AREAS AS A RESULT OF USE DURING CONSTRUCTION. DISTURBED AND DAMAGED AREAS SHALL BE RESTORED TO THEIR QRIGINAL CONDITION OR BETTER UPON COMPLETION OF WORK AT THE EXPENSE OF THE CONTRACTOR.
- 14. THE CONTRACTOR SHALL REMOVE WASTE, DEBRIS AND TRASH FROM SITE AND DISPOSE OF IN A LEGAL MANNER ON A DAILY BASIS.
- 15. CONTRACTOR SHALL COORDINATE THE CONSTRUCTION STAGING AREA AND PARKING WITH THE PROPERTY OWNER PRIOR TO THE CONSTRUCTION START DATE.
- 16. CONTRACTOR SHALL VERIFY WITH THE LOCAL AUTHORITIES (CITY, COUNTY, OR STATE) FOR THE GOVERNING BUILDING CODE.
- 17. THE CONTRACTOR SHALL NOT INTERFERE w/ THE FACILITY'S NORMAL OPERATIONS, ACCESS TO THE WORK AREA SHALL BE AS DIRECTED BY THE FACILITY'S OWNER.

- 18. THE CONTRACTOR SHALL CONFINE THEIR OPERATIONS TO THE DESIGNATED AREAS AND SHALL KEEP THE CONSTRUCTION AREA CLEAN. AISLES AND PATHWAYS SHALL BE KEPT UNOBSTRUCTED.
- 19. THE CONTRACTOR SHALL COORDINATE THE WORK OF VARIOUS TRADES SO AS TO INSURE PROPER SEQUENCING AND INSTALLATION.
- 20. CITY APPROVAL OF THE CONSTRUCTION SITE PLANS DOES NOT MEAN THAT ANY BUILDING CAN BE CONSTRUCTED ON THE LOTS WITHOUT MEETING THE BUILDING SETBACKS AS REQUIRED BY THE ZONING CODE.
- 21. ANY EXISTING WELLS AND/OR SPRINGS WHICH MAY EXIST ON THE PROPERTY MUST BE SEALED IN A MANNER ACCEPTABLE TO THE CITY OF O'FALLON CONSTRUCTION INSPECTION DEPARTMENT AND FOLLOWING MISSOURI DEPARTMENT OF NATURAL RESOURCES STANDARDS AND SPECIFICATIONS.





HIVERIAL FERNAL GIVE ER IN GIGHBAD Plays Suite 140 | Downers Grave, Illinois 902 07444 | sec 604.437 59600 | shive-bathery com

PROJECT NO: 8156607

ORAWN BY: JAP CHECKED BY: JMD

0 8/5/15 CLIENT REVIEW 1 9/23/15 BID/PERMIT 2 11/02/15 CITY COMMENTS 3 11/24/15 BIG REVIEW

MEXICO & SONDEREN SITE MO-2014-19
B365 MEXICO ROAD OF ALLON, MO B3365
ST. CHARLES COUNTY

SHEET TITLE GENERAL

NOTE8

SHEET NUMBER

N-1

ĽĽ 国

|| || || ||

PROJECT NO. 8158807 DRAWN BY: JAP

CHECKED BY: JMD

0 8/5/15 CLIENT REVIEW 9/23/15 BID/PERMIT 2 11/02/15 OTTY COMMENTS 3 11/24/15 DIG REVEW

MEXICO & SONDEREN SITE# MO-2014-19 8388 MEDICO ROAD O'FALLON, MO 63368 ST. CHARLES COUNTY

SHEET TITLE **GENERAL** NOTES

MONOPOLE

SHEET NUMBER

N-2

1. SITE AREA

- 1.1 VERIFY THAT SITE LOCATION CONFORMS TO THE SITE PLAN. THE FOUR (4) CORNERS OF THE SITE AREA SHALL BE STAKED AND ADEQUATE PRECAUTIONS SHALL BE TAKEN TO PROTECT THEM DURING THE CLEARING OPERATION, IF THE STAKES ARE MISSING OR DO NOT CONFORM TO INFORMATION ON SITE PLAN, CONSULT WITH THE PROJECT MANAGER.
- 1.2 A REGISTERED LAND SURVEYOR UNDER CONTRACT WITH THE TOWER OWNER SHALL STAKE OUT THE SITE AREA, ROAD AND GUY AREAS, CARELESS REMOVAL OF MARKERS. MONUMENTS OR STAKES SHALL BE REPLACED BY THE SURVEYOR AT COSTS TO THE CONTRACTOR.
- 1.3 THE SITE AREA SHALL BE GRADED TO PROVIDE A MAXIMUM SLOPE OF ONE PERCENT (1%) UNLESS OTHERWISE SPECIFIED & CAUSE SURFACE WATER TO FLOW AWAY FROM SHELTER / EQUIPMENT & TOWER AREAS.
- 1.4 GRADING SHALL NOT EXCEED THE LEASED OR PURCHASED PROPERTY LINES. SUB GRADE SHALL BE COMPACTED AND BROUGHT TO A SMOOTH UNIFORM GRADE PRIOR TO FINISHED SURFACE APPLICATION.
- 1.5 EXISTING INACTIVE UTILITIES WHICH PROHIBIT CONSTRUCTION SHALL BE REMOVED, CAPPED, PLUGGED OR OTHERWISE DISCONTINUED AS REQUIRED TO ALLOW CONSTRUCTION TO CONTINUE. COORDINATE WITH PROJECT MANAGER, OWNER, AND /OR LOCAL UTILITY COMPANIES FOR APPROVAL.
- 1.6 FILL OR EMBANKMENT MATERIAL SHALL NOT BE PLACED ON FROZEN GROUND, FROZEN MATERIALS, SNOW OR ICE SHALL NOT BE PLACED IN FILL OR EMBANKMENT.

2. SPECIAL REQUIREMENTS

- VERIFY THAT THE ACCESS ROAD RIGHT-OF-WAY AND SITE LOCATION CONFORM TO THE SITE PLAN AND DO NOT EXCEED LEASED OR PURCHASED PROPERTY LINES.
- COMPARE SURVEYOR STAKE POSITIONS WITH EXISTING USE OF AREA FOR CONFLICTS.
- 2.3 IF ACCESS ROAD ENTERS ROAD OR HIGHWAY, DETERMINE LOCAL PERMIT OR ENVIRONMENTAL REQUIREMENTS BEFORE CONSTRUCTION TO ENSURE COMPLIANCE.
- CLEARING AND GRUBBING SHALL BE RESTRICTED TO AREAS DETERMINED ON SPECIFIC PLAN FOR SITE, AREAS OF PROPERTY DISTURBED BY THE WORK AND NOT COVERED BY THE TOWER, EQUIPMENT OR DRIVEWAY, SHALL BE GRADED TO A UNIFORM SLOPE, AND STABILIZED TO PREVENT EROSION AS SPECIFIED ON THE PROJECT SPECIFICATIONS AND PER LOCAL MUNICIPALITY REQUIREMENTS.
- DISPOSAL OF ITEMS REMOVED SHALL BE IN ACCORDANCE WITH THE PROJECT MANAGER AND/OR LOCAL ORDINANCES.
- SITE SIGNAGE SHALL BE PROVIDED IN ACCORDANCE WITH THE TOWER OWNER TECHNICAL SPECIFICATIONS FOR SITE SIGNAGE & LOCAL SIGN ORDINANCES/REQUIREMENTS.

3. ACCESS ROAD

- VERIFY WITH THE LANDOWNER (IF OTHER THAN TOWER OWNER), BEFORE STARTING CONSTRUCTION TO ENSURE THEIR UNDERSTANDING OF CONSTRUCTION ACTIVITY.
- 3.2 ROAD SHALL BE CONSTRUCTED PROPERLY WITH RESPECT TO LINES AND GRADES, EACH SITE SHALL HAVE DIFFERENT CONSIDERATIONS DURING CONSTRUCTION TO AVOID PROBLEMS IN THE FUTURE (I.E. SWAMPS, BOGS, STEEP INCLINES, UNSTABLE SQIL, SOLID ROCK AND LAYERED ROCK). ROAD SHALL BE BUILT-UP AND CROWNED. DEEP INITIAL CUTS SHALL BE AVOIDED. REFERENCE DETAILS FOR TYPICAL CROSS SECTION.
- SUITABLE BASE COARSE MATERIALS SHALL BE USED. REFERENCE DETAILS FOR TYPICAL CROSS SECTION SHOWING PREFERRED MATERIALS.

- BASE COARSE SHALL BE APPLIED IN MAXIMUM 5" LAYERS AND COMPACTED, THE MATERIAL SHALL BE DAMP FOR GOOD COMPACTING.
- IN SITUATIONS WHERE WATER IS PREVALENT NEAR THE SURFACE (SUB-GRADE), THE USE OF 6 OZ. GEOTEXTILE BY TENCATE OR EQUIVALENT TYPE MATERIAL, TO RETAIN SOIL AND PERMIT WATER TO FLOW IS REQUIRED. LARGE BASE MATERIAL MINIMUM 4" SHALL BE USED.
- IF THE AREA WHERE THE ACCESS ROAD IS BEING CONSTRUCTED IS BEING USED FOR ANIMAL CONTAINMENT, SAFEGUARDS SHALL BE TAKEN TO PREVENT THEIR ESCAPE UNTIL PERMANENT GUARDS OR FENCING CAN BE INSTALLED.
- CHANGES IN METHODS OR MATERIALS MUST BE APPROVED IN ADVANCE BY THE PROJECT MANAGER.

4. DRAINAGE

- DRAINAGE DITCHES SHALL BE DEEP AND WIDE ENOUGH TO CONTROL THE WATER RUN OFF, CHECK DAMS SHALL BE INSTALLED IN DITCHES ON SLOPES OF GREATER THAN 10 PERCENT (10%).
- DRAINAGE DITCHES SHALL NOT CREATE WATER PROBLEMS WITH THE LANDLORD OR LOCAL RESIDENTS. LOCAL PERMITS AND ENVIRONMENTAL REQUIREMENTS MUST BE VERIFIED PRIOR TO DE-WATERING.
- DRAINAGE DITCHES SHALL BE PROTECTED FROM EROSION WITH SEEDING. 4.3 RIP-RAP OR SOD AS REQUIRED BY LOCAL REQUIREMENTS.
- CULVERTS SHALL BE INSTALLED ACCORDING TO THE SITE PLAN AND SITE CONDITIONS. VERIFY WITH THE HIGHWAY DEPARTMENT TO DETERMINE THE TYPE AND SIZE OF CULVERT REQUIRED WHEN THE ACCESS ROAD ENTERS A ROAD OR HIGHWAY, CULVERTS AT THE ENTRANCE TO THE ACCESS ROAD SHALL BE A MINIMUM 18" DIAMETER AND 40' IN LENGTH.
- CULVERTS SHALL HAVE SUFFICIENT COVER OVER THE PIPE SO THAT THE MOUTH OF THE CULVERT IS PROTECTED AGAINST JAMMING OR COLLAPSE.
- CULVERTS SHALL HAVE, AT EACH END, A MINIMUM 30 SQ FT LAYER OF 5" ROCK.
- ADEQUATE PROVISIONS SHALL BE TAKEN FOR WATER DRAINAGE IN LOW-LYING AREAS.
- IN THE OCCURRENCE OF LOCATING EXISTING FIELD TILE: CARE MUST BE TAKEN BY CONTRACTOR NOT TO DESTROY TILE FOR DRAINAGE, FIELD TILE DESTROYED BY CONTRACTOR MUST BE REPAIRED BY SUCH CONTRACTOR AT CONTRACTOR'S EXPENSE.

5. GRADING / SEDIMENT & EROSION CONTROL:

- 5.1 SEDIMENT AND EROSION CONTROL SHALL NOT BE LIMITED TO THE MEASURES SHOWN ON THE PLANS. THE CONTRACTOR, WITH THE APPROVAL OF THE LOCAL INSPECTOR, SHALL UTILIZE BEST MANAGEMENT PRACTICES TO PREVENT SEDIMENT FROM ENTERING ADJACENT PROPERTIES, ROADWAYS, STORM SEWERS, AND DRAINAGEWAYS.
- 5.2 FILLED PLACES UNDER PROPOSED STORM AND SANITARY SEWER LINES AND/OR PAVED AREAS INCLUDING TRENCH BACKFILLS WITHIN AND OFF THE ROAD RIGHT-OF-WAY SHALL BE COMPACTED TO 90 PERCENT OF MAXIMUM DENSITY AS DETERMINED BY THE "MODIFIED AASHTO T-180 COMPACTION TEST" (ASTM D-1557). TESTS SHALL BE VERIFIED BY A SOILS ENGINEER CONCURRENT WITH GRADING AND BACKFILLING OPERATIONS.
- DEBRIS AND FOUNDATION MATERIAL FROM EXISTING ON-SITE BUILDING OR STRUCTURE WHICH IS SCHEDULED TO BE REMOVED FOR THIS DEVELOPMENT MUST BE PROPERLY DISPOSED OF OFF-SITE.
- SOFT SOILS IN THE BOTTOM AND BANKS OF EXISTING OR FORMER POND SITES OR TRIBUTARIES OR SEDIMENT BASINS OR TRAPS SHOULD BE REMOVED, SPREAD OUT AND PERMITTED TO DRY SUFFICIENTLY TO BE USED AS FILL NONE OF THIS MATERIAL SHOULD BE PLACED IN PROPOSED PUBLIC RIGHT-OF-WAY LOCATIONS OR ON STORM SEWER LOCATION.

- A PRE-CONSTRUCTION REVIEW CONFERENCE MUST BE SCHEDULED WITH THE CONSTRUCTION MANAGER PRIOR TO THE START OF EACH CONSTRUCTION PHASE OF LAND DISTURBANCE ACTIVITY. THE PERMITEE WILL BE RESPONSIBLE FOR NOTIFYING CONTRACTORS. UTILITY CREWS, AND OTHER ENTITIES THAT WILL PERFORM WORK AT THE SITE TO BE IN ATTENDANCE.
- NOTIFY THE EROSION CONTROL INSPECTOR OF THE JURISDICTION (IF APPLICABLE), A MINIMUM OF 48 HOURS PRIOR TO THE COMMENCEMENT OF CLEARING, GRADING, AND/OR PRIOR TO THE COMMENCEMENT OF CONSTRUCTION TO ARRANGE FOR AN INSPECTION. OF THE SITE.
- TEMPORARY SILTATION CONTROL MEASURES (STRUCTURAL) SHALL BE MAINTAINED UNTIL VEGETATIVE COVER IS ESTABLISHED AT A SUFFICIENT DENSITY TO PROVIDE EROSION CONTROL ON THE SITE.
- UPON COMPLETION OF STORM SEWERS, SILTATION CONTROL SHALL BE PROVIDED AROUND OPEN SEWER INLETS AND SHALL REMAIN UNTIL THE DISTURBED DRAINAGE AREAS HAVE BEEN PROPERLY STABILIZED.
- WHERE NATURAL VEGETATION IS REMOVED DURING GRADING. VEGETATION SHALL BE RE-ESTABLISHED IN SUCH A DENSITY AS TO PREVENT EROSION.
- WHEN GRADING OPERATIONS ARE COMPLETED OR SUSPENDED FOR MORE THAN 30 DAYS, PERMANENT GRASS MUST BE ESTABLISHED AT SUFFICIENT DENSITY TO PROVIDE EROSION CONTROL ON THE SITE. BETWEEN PERMANENT GRASS SEEDING PERIODS, TEMPORARY COVER SHALL BE PROVIDED ACCORDING TO THE RECOMMENDATION OF THE JURISDICTIONAL REQUIREMENTS (IF APPLICABLE) OR STANDARD STATE ADOPTED PROCEDURE WHERE LOCAL REQUIREMENTS ARE NOT SPECIFIED. FINISHED GRADES IN EXCESS OF 20% SLOPES (5:1) SHALL BE MULCHED AND TACKED AT THE RATE OF 100 POUNDS PER 1,000 SQUARE FEET WHEN SEEDED.

TEOFMISSOURILL WILLIAM C. THOMPSON, JR. 🗠 NUMBER E-22147 S WILLIAM C. THEMPSIN, JR., REGISTERED PROFESSIONAL ENGINEER REGISTRATION NUMBER: E-22147

GENERAL STEEL NOTES:

- 1. STEEL WORK SHALL BE GALVANIZED UNLESS NOTED OTHERWISE.
- NON-GALVANIZED STEEL WORK SHALL BE PAINTED IN ACCORDANCE WITH THE PROJECT SPECIFICATIONS AND IN ACCORDANCE WITH ASTM A36 UNLESS NOTED OTHERWISE.
- 3. WELDING SHALL BE PERFORMED BY CERTIFIED WELDERS USING E70XX ELECTRODES. WELDING SHALL CONFORM TO AISC & AWS D1.1. WHERE FILLET WELD SIZES ARE NOT SHOWN, PROVIDE THE MINIMUM SIZE PER TABLE J2.4 IN THE AISC "MANUAL OF STEEL CONSTRUCTION", LATEST EDITION. AT THE COMPLETION OF WELDING, DAMAGE TO GALVANIZED COATING SHALL BE REPAIRED.
- 4. STEEL BOLTING ASTM A325—N BOLTS, SEE PLAN/DETAILS FOR DIAMETER, NON SLIP CRITICAL CONNECTIONS AND SHALL HAVE MINIMUM OF TWO BOLTS UNLESS NOTED OTHERWISE.
- DAMAGE TO THE EXISTING FACILITY SHALL BE REPAIRED OR REPLACED TO MATCH EXISTING ORIGINAL CONDITIONS AT THE CONTRACTOR'S EXPENSE.
- STEEL DESIGN, FABRICATION AND ERECTION SHALL BE IN ACCORDANCE WITH AISC STANDARDS LATEST EDITION.
- STEEL W SHAPES SHALL CONFORM TO ASTM A992 (MINIMUM YIELD STRENGTH=50KSI) GRADE 50.
- SIZE STANDARD BEAM CONNECTIONS BASED ON 3/4 OF THE TOTAL UNIFORM LOAD CAPACITY OF THE BEAM. USE DOUBLE CLIP ANGLES AND AISC TABLE 10-1 UNLESS INDICATED OTHERWISE.

- 9. STEEL ANGLES AND PLATES ASTM A36. (MINIMUM YIELD STRENGTH =
- 36KSI)

 10. STEEL TUBE SHAPES ASTM A500 GRADE B. (MINIMUM YIELD STRENGTH = 46KSI)
- 11. STEEL PIPES ASTM A53 TYPE E. (MINIMUM YIELD STRENGTH = 35KSI)
- CONTRACTOR SHALL COORDINATE AND VERIFY LAYOUT, PLACEMENT, ETC. OF EQUIPMENT PRIOR TO FABRICATION AND ERECTION.
- 13. VERIFY EQUIPMENT MOUNTING DIMENSIONS PER MANUFACTURER DRAWINGS.
- 14. INSTALLATION OF CONCRETE EXPANSION/WEDGE ANCHOR, SHALL BE PER MANUFACTURER'S RECOMMENDED PROCEDURE. THE ANCHOR BOLT, DOWEL OR ROD SHALL CONFORM TO MANUFACTURER'S RECOMMENDATION FOR EMBEDMENT DEPTH OR AS SHOWN ON THE DRAWINGS. NO REBAR SHALL BE CUT WITHOUT PRIOR CONTRACTOR APPROVAL WHEN DRILLING HOLES IN CONCRETE. SPECIAL INSPECTIONS, REQUIRED BY GOVERNING CODES, SHALL BE PERFORMED IN ORDER TO MAINTAIN MANUFACTURER'S MAXIMUM ALLOWABLE LOADS.

SH-01-NO-04-009

CONCRETE & REINFORCING STEEL NOTES

- CONCRETE WORK SHALL BE IN ACCORDANCE WITH THE ACI 301, ACI 318 AND THE SPECIFICATION FOR CAST—IN—PLACE CONCRETE.
- 2. CONCRETE SHALL HAVE A MINIMUM COMPRESSIVE STRENGTH OF 4000 PSI AT 28 DAYS. STRUCTURE MAY BE INSTALLED ON FOUNDATION AT A TIME EARLIER THAN 28 DAYS WITH CONFIRMING CONCRETE CYLINDER TEST RESULTS. AT CONTRACTOR'S OPTION, A HIGH EARLY STRENGTH (TYPE III) CEMENT OR A STRENGTH ACCELERATING ADMIXTURE MAY BE USED. NO CALCIUM CHLORIDE ALLOWED. SUBMIT DESIGN MIX FOR APPROVAL.
- REINFORCING STEEL SHALL CONFORM TO ASTM A615, GRADE 60, DEFORMED UNLESS NOTED OTHERWISE. WELDED WIRE FABRIC SHALL CONFORM TO ASTM A185 WELDED STEEL WIRE FABRIC, U.N.O. SPLICES SHALL BE CLASS "B" AND HOOKS SHALL BE STANDARD, U.N.O.
- 4. REINFORCING STEEL SHALL BE DETAILED IN ACCORDANCE WITH THE ACI "MANUAL OF STANDARD PRACTICE FOR DETAILING REINFORCED CONCRETE STRUCTURES", LATEST EDITION.
- THE FOLLOWING MINIMUM CONCRETE COVER SHALL BE PROVIDED FOR REINFORCING STEEL UNLESS SHOWN OTHERWISE ON DRAWINGS:

CONCRETE CAST AGAINST EARTH......3 IN.
CONCRETE EXPOSED TO EARTH OR WEATHER:
#6 AND LARGER......2 IN.
#5 AND SMALLER & WWF...1 1/2 IN.


- A 3/4" CHAMFER SHALL BE PROVIDED AT EXPOSED EDGES OF CONCRETE, U.N.O., IN ACCORDANCE WITH ACI 301 SECTION 4.2.4.
- SAMPLES FOR STRENGTH TESTS SHALL BE TAKEN IN ACCORDANCE WITH ASTM C172.
- CYLINDERS FOR STRENGTH TESTS SHALL BE IN ACCORDANCE WITH ASTM C31 AND TESTED IN ACCORDANCE WITH ASTM C39.
- SAMPLES FOR STRENGTH TESTS SHALL BE IN ACCORDANCE WITH ACI 318 WITH A MINIMUM OF (4) CYLINDERS. (1) 7 DAY, (1) 14 DAY AND (2) 28 DAY.

- 10. SCOPE / SUBMITTALS
 CONCRETE FOR SHELTER FOUNDATION AND FENCE POST SETTING SUBMIT PROPOSED MODIFICATIONS TO THESE DRAWINGS AND
 SPECIFICATIONS FOR APPROVAL BY TOWER OWNER.
- 11. QUALITY STANDARDS

 QUALITY STANDARDS COMPLY WITH THE STANDARDS OF THE AMERICAN

 CONCRETE INSTITUTE, THE CONCRETE REINFORCING STEEL INSTITUTE, AND

 APPLICABLE ASTM REQUIREMENTS.
- 12. FORMWORK MATERIALS
 CONCRETE HAS GENERALLY BEEN DESIGNED FOR PLACEMENT AGAINST EARTH
 OR FILL MATERIALS, HOWEVER, THE TOP 4-FOOT MINIMUM OF SHELTER AND
 TOWER FOUNDATIONS SHALL BE PLACED USING FORMS. CONSTRUCT FORMWORK
 TO PROVIDE FINISHED CONCRETE ACCURATE TO LINES AND LEVELS SHOWN ON
 THE DRAWINGS. CONSTRUCT FORMWORK WITH TIGHT JOINTS TO MINIMIZE
 LEAKAGE. INCLUDE ACCESSORIES NECESSARY TO SUPPORT EMBEDDED ITEMS
 DURING PLACEMENT OF CONCRETE.
- 13. PLACEMENT AND FINISHING
 INSTALL FORMWORK AND REINFORCING AS REQUIRED FOR CONFIGURATION OF
 CONCRETE SHOWN ON THE DRAWINGS. PLACE CONCRETE CONTINUOUSLY IN
 EACH LOCATION. CONSOLIDATE CONCRETE USING EQUIPMENT APPROPRIATE TO
 EACH CONDITION, LIMITING THE DURATION TO PREVENT BRINGING AN EXCESS
 OF FINE AGGREGATE TO THE SURFACE. BRING SURFACES TO CORRECT LEVEL
 WITH STRAIGHT EDGE, FLOAT SMOOTH AND TROWEL TO A HARD, DENSE FINISH
 HAVING A TOLERANCE OF 1/8" IN 10'-0". EXTERIOR WALKING SURFACES
 SHALL BE GIVEN A BROOMED FINISH PERPENDICULAR TO DIRECTION OF
 TRAVEL. HOT AND COLD WEATHER PLACEMENT SHALL BE IN ACCORDANCE
 WITH THE REQUIREMENTS OF ACI 305 AND 306.

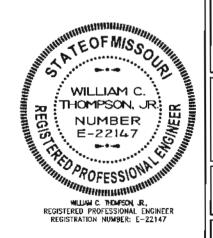

ST. CHARLES
TOWER

SHIVEHIATTE 3 C H I T E C T U R E + E N G I N E 5 Highland Play Sulte 140 | Downers Grove, 390 7444 | fax 630 437 5900 | shive-hattery I Illinois | Missouri

PROJECT NO: 8156607

DRAWN 8Y: JAP

D 8/5/15 CLENT REVIEW
1 9/23/15 BID/PERMIT
2 11/02/15 CTTY COMMENTS
3 11/24/15 ENG REVIEW

MEXICO & SONDEREN SITE MO-2014-19 ESSE MEXICO ROAD O'FALLOR MO 63366 ST. CHARLES COUNTY

SHEET TITLE GENERAL

NOTE8

ELECTRICAL INSTALLATION NOTES:

SPECIFICATIONS, NEC ANDAPPLICABLE LOCAL CODES.

17. GALVANIZED STEEL RIGID METAL CONDUIT (RMC) SHALL BE USED FOR OUTDOOR LOCATIONS ABOVE GRADE.

SCHEDULE 80) SHALL BE USED UNDERGROUND: DIRECT BURIED. IN AREAS OF

OCCASIONAL LIGHT VEHICLE TRAFFIC OR ENCASED IN REINFORCED CONCRETE IN

18. RIGID NONMETALLIC CONDUIT (I.E. RIGID PVC SCHEDULE 40 OR RIGID PVC

- 1. CONTRACTOR SHALL PROVIDE LABOR, MATERIALS, EQUIPMENT AND SERVICES NECESSARY FOR AND INCIDENTAL TO THE COMPLETE INSTALLATION AND OPERATION OF ELECTRICAL WORK.
- 2. CONDUIT ROUTINGS ARE SCHEMATIC. SUBCONTRACTOR SHALL INSTALL CONDUITS SO THAT ACCESS TO EQUIPMENT IS NOT BLOCKED.

ELECTRICAL WORK SHALL BE PERFORMED IN ACCORDANCE WITH THE PROJECT

- 2. CONTRACTOR SHALL CONFORM TO THE REQUIREMENT OF THE RULES, REGULATIONS, AND CODES OF LOCAL, STATE, AND FEDERAL AUTHORITIES HAVING JURISDICTION, AND CONFORM TO THE NATIONAL ELECTRICAL SAFETY CODES, AND NATIONAL ELECTRICAL CONTRACTORS ASSOCIATION LATEST EDITIONS.
- WIRING, RACEWAY AND SUPPORT METHODS AND MATERIALS SHALL COMPLY WITH THE REQUIREMENTS OF THE NEC.
- 3. CONTRACTOR SHALL NOTE THAT DRAWINGS ARE GENERALLY DIAGRAMMATIC. BENDS, FITTINGS AND ACCESSORIES ARE NOT NECESSARILY SHOWN. PROVIDE SUCH ITEMS AS
- AS REQUIRED BY THE NEC.
- 4. CONTRACTOR SHALL BE RESPONSIBLE FOR VERIFICATION & INSTALLATION OF ELECTRICAL SERVICE CABLE SIZES & RUNS BASED ON LOCAL CODE REQUIREMENTS & OR NEC (LATEST ENFORCED EDITIONS), CHANGE ORDERS WILL NOT BE ACCEPTED DUE TO LACK OF VERIFICATION.

LOCATE NAMEPLATE, MARKING, OR OTHER IDENTIFICATION

MEANS ON OUTSIDE EQUIPMENT OR BOX FRONT COVERS.

DURING TRENCH BACK-FILLING FOR EACH UNDERGROUND

ELECTRICAL, TELEPHONE, SIGNAL AND COMMUNICATIONS

LINE. PROVIDE A CONTINUOUS UNDERGROUND WARNING

IDENTIFYING LOAD SERVED OR "SPARE" OR "SPACE" FOR

EACH CIRCUIT POLE. WHEN MODIFYING CIRCUITS, UPDATE

THE EXISTING (OR PROVIDE NEW) CIRCUIT DIRECTORY CARD TO ACCURATELY REFLECT FINAL CONDITIONS.

TAPE SIX INCHES BELOW FINISHED GRADE. WARNING

TAPE SHALL BE TYPE IID. DETECTABLE THREE LAYER

4. AT COMPLETION OF PROJECT, ACCURATELY COMPLETE

EACH PANELBOARD CIRCUIT DIRECTORY CARD,

PROVIDE NAMEPLATE ENGRAVED WITH EQUIPMENT

DESIGNATION FOR EACH SAFETY SWITCH AND OTHER

ELECTRICAL IDENTIFICATION:

GENERAL:

NAMEPLATES:

LAMINATE.

ELECTRICAL CABINETS.

3. UNDERGROUND WARNING TAPE:

- 4. CIRCUITS SHALL BE SEGREGATED AND MAINTAIN MINIMUM CABLE SEPARATION
- CABLES SHALL NOT BE ROUTED THROUGH LADDER-STYLE CABLE TRAY RUNGS.
- 6. EACH END OF EVERY POWER, POWER PHASE CONDUCTOR (I.E., HOTS), GROUNDING AND TI CONDUCTOR AND CABLE SHALL BE LABELED WITH COLOR-CODED INSULATION OR ELECTRICAL TAPE (3M BRAND, 1/2" PLASTIC ELECTRICAL TAPE WITH UV PROTECTION, OR EQUAL), THE IDENTIFICATION METHOD SHALL CONFORM WITH NEC AND OSHA.
- 7. ELECTRICAL COMPONENTS SHALL BE CLEARLY LABELED WITH PLASTIC TAPE PER COLOR SCHEDULE, EQUIPMENT SHALL BE LABELED WITH THEIR VOLTAGE RATING, PHASE CONFIGURATION, WIRE CONFIGURATION, POWER OR AMPACITY RATING ANO BRANCH CIRCUIT ID NUMBERS (I.E. PANEL BOARD AND CIRCUIT ID'S),
- 8. PANEL BOARDS (ID NUMBERS) AND INTERNAL CIRCUIT BREAKERS (CIRCUIT ID NUMBERS) SHALL BE CLEARLY LABELED WITH PLASTIC LABELS.
- 9. TIE WRAPS SHALL BE CUT FLUSH WITH APPROVED CUTTING TOOL TO REMOVE SHARP EDGES.
- 10. POWER, CONTROL AND EQUIPMENT GROUND WIRING IN TUBING OR CONDUIT SHALL BE SINGLE CONDUCTOR (14 AWG OR LARGER), 600 V, OIL RESISTANT THHN OR THWN-2, CLASS B STRANDED COPPER CABLE RATED FOR 90°C (WET & DRY) OPERATION LISTED OR LABELED FOR THE LOCATION AND RACEWAY SYSTEM USED UNLESS OTHERWISE SPECIFIED.
- 11. SUPPLEMENTAL EQUIPMENT GROUND WIRING LOCATED INDOORS SHALL BE SINGLE CONDUCTOR (6 AWG OR LARGER), 600V, OIL RESISTANT THHN OR THWN-2 GREEN INSULATION CLASS B STRANDED COPPER CABLE RATED FOR 90°C (WET AND DRY) OPERATION LISTED OR LABELED FOR THE LOCATION AND RACEWAY SYSTEM USED UNLESS OTHERWISE SPECIFIED.
- 12. POWER AND CONTROL WIRING, NOT IN TUBING OR CONDUIT, SHALL BE MULTI-CONDUCTOR, TYPE TC CABLE (14 AWG OR LARGER), 600 V, OIL RESISTANT THHN OR THWN-2. CLASS B STRANDED COPPER CABLE RATED FOR 90°C (WET AND DRY) OPERATION WITH OUTER JACKET LISTED OR LABELED FOR THE LOCATION USED UNLESS OTHERWISE SPECIFIED.
- 13. POWER AND GROUNDING CONNECTIONS SHALL BE CRIMP-STYLE, COMPRESSION WIRE LUGS AND WIRE NUTS BY THOMAS AND BETTS (OR EQUAL), LUGS AND WIRE NUTS SHALL BE RATED FOR OPERATION AT NO LESS THAN 75" C (90" C IF AVAILABLE).
- 14. RACEWAY AND CABLE TRAY SHALL BE LISTED OR LABELED FOR ELECTRICAL USE IN ACCORDANCE WITH NEMA, UL, ANSI/IEEE AND NEC.
- 15. ELECTRICAL METALLIC TUBING (EMT) OR RIGID NONMETALLIC CONDUIT (I.E. RIGID PVC SCHEDULE 40 OR RIGID PVC SCHEDULE 80 FOR LOCATIONS SUBJECT TO PHYSICAL DAMAGE) SHALL BE USED FOR EXPOSED INDOOR LOCATIONS.
- 16. ELECTRICAL METALLIC TUBING (EMT), ELECTRICAL NONMETALLIC TUBING (ENT) OR RIGID NONMETALLIC CONDUIT (RIGID PVC, SCHEDULE 40) SHALL BE USED FOR CONCEALED INDOOR LOCATIONS.

- AREAS OF HEAVY VEHICLE TRAFFIC. 19. LIQUID-TIGHT FLEXIBLE METALLIC CONDUIT (LIQUID-TITE FLEX) SHALL BE USED INDOORS AND OUTDOORS. WHERE VIBRATION OCCURS OR FLEXIBILITY IS NEEDED.
- 2D. CONDUIT AND TUBING FITTINGS SHALL BE THREADED OR COMPRESSION-TYPE AND APPROVED FOR THE LOCATION USED, SET SCREW FITTINGS ARE NOT ACCEPTABLE.
- 21. CABINETS, BOXES AND WIRE WAYS SHALL BE LABELED FOR ELECTRICAL USE IN ACCORDANCE WITH NEMA, UL. ANSI/IEEE AND NEC.
- 22. WIREWAYS SHALL BE EPOXY-COATED (GRAY) AND INCLUDE A HINGED COVER, DESIGNED TO SWING OPEN DOWNWARDS; SHALL BE PANDUIT TYPE E (OR EQUAL); AND RATED NEMA 1 (OR BETTER).
- 23. EQUIPMENT CABINETS, TERMINAL BOXES, JUNCTION BOXES AND PULL BOXES SHALL BE GALVANIZED OR EPOXY-COATED SHEET STEEL, SHALL MEET OR EXCEED UL 50 AND RATED NEMA 1 (OR BETTER) INDOORS OR NEMA 3R (OR BETTER) OUTDOORS,
- 24. METAL RECEPTACLE, SWITCH AND DEVICE BOXES SHALL BE GALVANIZED. EPOXY-COATED OR NON-CORRODING; SHALL MEET OR EXCEED UL 514A AND NEMA OS 1; AND RATED NEMA 1 (OR BETTER) INDOORS OR WEATHER PROTECTED (WP OR BETTER) OUTDOORS.
- 25. NONMETALLIC RECEPTACLE, SWITCH AND DEVICE BOXES SHALL MEET OR EXCEED NEMA OS 2; AND RATED NEMA 1 (OR BETTER) INDOORS OR WEATHER PROTECTED (WP OR BETTER) OUTDOORS.
- 26. THE SUBCONTRACTOR SHALL NOTIFY AND OBTAIN NECESSARY AUTHORIZATION FROM THE CONTRACTOR BEFORE COMMENCING WORK ON THE AC POWER DISTRIBUTION PANELS.
- 27. THE SUBCONTRACTOR SHALL PROVIDE NECESSARY TAGGING ON THE BREAKERS. CABLES AND DISTRIBUTION PANELS IN ACCORDANCE WITH THE APPLICABLE CODES AND STANDARDS TO SAFEGUARD AGAINST LIFE AND PROPERTY.
- 28. UTILITY POLES SHALL BE 35 FT., CLASS 4., UNO OR AS REQUIRED BY LOCAL UTILITY COMPANIES.

Ľ

SH-01-NO-07-001

ΩŽ ₹ ₹¥₹

PROJECT NO: 8156607 DRAWN BY: JAP

CHECKED BY: JMD 0 8/3/15 CLIENT REVIEW 1 9/23/15 BID/PERMIT 2 11/02/15 OTTY COMMENTS 3 11/24/15 ENG REVIEW

TEOF M/S COUNTY MARTIN ALENTINE: NUMBER 2007005050 COOONAL ENGINEERS

MARTIN VALENTINE., PROFESSIONAL ENGINEER REGISTRATION NUMBER: 2007005050

aummu_{tti}

SHEET NUMBER


N-4

SITE# MO-2014-19 8368 MEXICO ROAD O'FALLON, MO 83366 ST. CHARLES COUNTY MONOPOLE SHEET TITLE ELECTRICAL NOTES

MEXICO &

SONDEREN

- 1. GROUND ELECTRODE SYSTEMS (INCLUDING TELECOMMUNICATION, RADIO, LIGHTNING PROTECTION AND AC POWER GES'S) SHALL BE BONDED TOGETHER AT OR BELOW GRADE, BY TWO OR MORE COPPER BONDING CONDUCTORS IN ACCORDANCE WITH THE NEC.
- THE SUBCONTRACTOR SHALL PERFORM IEEE FALL-OF-POTENTAL RESISTANCE TO EARTH TESTING (PER IEEE 1100 AND 81) FOR GROUND ELECTRODE
 SYSTEMS, THE SUBCONTRACTOR SHALL FURNISH AND INSTALL SUPPLEMENTAL GROUND ELECTRODES AS NEEDED TO ACHIEVE A TEST RESULT OF 5
 OHMS OR LESS.
- 3. THE SUBCONTRACTOR IS RESPONSIBLE FOR PROPERLY SEQUENCING GROUNDING AND UNDERGROUND CONDUIT INSTALLATION AS TO PREVENT LOSS OF CONTINUITY IN THE GROUNDING SYSTEM OR DAMAGE TO THE CONDUIT AND PROVIDE TESTING RESULTS.
- 4. METAL CONDUIT AND TRAY SHALL BE GROUNDED AND MADE ELECTRICALLY CONTINUOUS WITH LISTED BONDING FITTINGS OR BY BONDING ACROSS
 THE DISCONTINUITY WITH 6 AWG CU WIRE UL APPROVED GROUNDING TYPE CONOUIT CLAMPS.
- 5. METAL RACEWAY SHALL NOT BE USED AS THE NEC REQUIRED EQUIPMENT GROUND CONDUCTOR. STRANDED COPPER CONDUCTORS WITH GREEN INSULATION, SIZED IN ACCORDANCE WITH THE NEC, SHALL BE FURNISHED AND INSTALLED WITH THE POWER CIRCUITS TO BTS EQUIPMENT.
- 6. EACH BTS CABINET FRAME SHALL BE DIRECTLY CONNECTED TO THE MASTER GROUND BAR WITH GREEN INSULATED SUPPLEMENTAL EQUIPMENT GROUND WIRES, 6 AWG STRANDED COPPER OR LARGER FOR INDOOR BTS; 2 AWG SOLID TINNED COPPER FOR OUTDOOR BTS.
- 7. CONNECTIONS TO THE GROUND BUS SHALL NOT BE DOUBLED UP OR STACKED, BACK TO BACK CONNECTIONS ON OPPOSITE SIDE OF THE GROUND BUS ARE PERMITTED.
- EXTERIOR GROUND CONDUCTORS BETWEEN EQUIPMENT/GROUND BARS AND THE GROUND RING SHALL BE 2 AWG SOLID TINNED BCW UNLESS
 OTHERWISE INDICATED.
- ALUMINUM CONDUCTOR OR COPPER CLAD STEEL CONDUCTOR SHALL NOT BE USED FOR GROUNDING CONNECTIONS.
- 10. USE OF 90" BENDS IN THE PROTECTION GROUNDING CONDUCTORS SHALL BE AVOIDED WHEN 45" BENDS CAN BE ADEQUATELY SUPPORTED.
- 11. EXOTHERMIC WELDS SHALL BE USED FOR GROUNDING CONNECTIONS BELOW GRADE.
- 12. GROUND CONNECTIONS ABOVE GRADE (INTERIOR AND EXTERIOR) SHALL BE FORMED USING HIGH PRESSURE CRIMPS.
- 13. COMPRESSION GROUND CONNECTIONS MAY BE REPLACED BY EXOTHERMIC WELD CONNECTIONS.
- 14. ICE BRIDGE BONOING CONDUCTORS SHALL BE EXOTHERMICALLY BONDED OR BOLTED TO THE BRIDGE AND THE TOWER GROUND BAR.
- 15. APPROVED ANTIOXIDANT COATINGS (I.E. CONDUCTIVE GEL OR PASTE) SHALL BE USED ON COMPRESSION AND BOLTED GROUND CONNECTIONS.
- 16. EXTERIOR GROUND CONNECTIONS SHALL BE COATED WITH A CORROSION RESISTANT MATERIAL
- 17. MISCELLANEOUS ELECTRICAL AND NON-ELECTRICAL METAL BOXES, FRAMES AND SUPPORTS SHALL BE BONDED TO THE GROUND CONNECTIONS.
- 18. BOND METALLIC OBJECTS WITHIN 6 FT. OF MAIN GROUND WIRES WITH 1-2 AWG TIN-PLATED COPPER GROUND CONDUCTOR.
- 19. GROUND CONDUCTORS USED IN THE FACILITY GROUND AND LIGHTNING PROTECTION SYSTEMS SHALL NOT BE ROUTED THROUGH METALLIC OBJECTS THAT FORM A RING AROUND THE CONDUCTOR, SUCH AS METALLIC CONDUITS, METAL SUPPORT CLIPS OR SLEEVES THROUGH WALLS OR FLOORS, WHEN IT IS REQUIRED TO BE HOUSED IN CONDUIT TO MEET CODE REQUIREMENTS OR LOCAL CONDUITIONS, NON-METALLIC MATERIAL SUCH AS PVC PLASTIC CONDUIT SHALL BE USED. WHERE USE OF METAL CONDUIT IS UNAVOIDABLE (E.G., NONMETALLIC CONDUIT PROHIBITED BY LOCAL CODE) THE GROUND CONDUCTOR SHALL BE BONOED TO EACH END OF THE METAL CONDUIT.

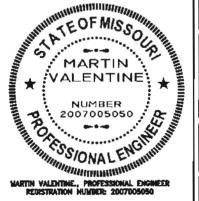

ST. CHARLES
TOWER

SHIVEHIATTER
R CHITECTURE + ENGINE ER
SHOPPING SAUGH STERM
3907444 | Fax 630 437 5800 | shiwe-hetteny con

PROJECT NO. 8158807 GRAWN BY: JAP

CHECKED BY: JMD


0 8/5/15 CLIENT REVIEW 1 9/23/15 BID/PERMIT 2 11/02/15 CITY COMMENTS 3 11/24/15 BNG REVIEW

MEXICO & SONDEREN BITE# MO-2014-19

8388 MEDICO ROAD O'FALLON, MO 83388 ST. CHARLES COUNTY MONOPOLE

> SHEET TITLE GROUNDING NOTES

PLAN S	YMBOLS	UTILITY PL	AN SYMBOLS	GROUNI	DING PLAN SYMBOLS	ABBREVIATIONS				
PLAN SY PLAN SY PLAN SY SO STATE OF THE	NEW ANTENNA EXISTING ANTENNAS NEW PARKING BOLLARD EXISTING PARKING BOLLARD BENCH MARK TOWER CENTER FOUND MONUMENT SPOT ELEVATION REVISION GRID REFERENCE DETAIL REFERENCE ELEVATION SECTIONS & DETAILS ELEVATION TAG CENTER LINE PROPERTY LINE GROUND WIRE COAXIAL CABLE EXISTING CONTOUR LINE EXISTING FENCE NEW FENCE	UTILITY PL	TELEPHONE PEDESTAL ELECTRIC BOX PAD MOUNTED TRANSFORMER EXISTING UTILITY POLE NEW UTILITY POLE GUY ANCHOR LIGHT POLE EXISTING OVERHEAD TELEPHONE NEW OVERHEAD TELEPHONE EXISTING UNDERGROUND TELEPHONE NEW UNDERGROUND TELEPHONE EXISTING OVERHEAD POWER NEW UNDERGROUND POWER	• ⊗ ⊠ 	EXOTHERMIC WELD BOLTED CONNECTION GROUND BAR GROUND ROD GROUND ACCESS PORT GROUND RING/GROUND CONDUCTOR COILED GROUND CONNECTION	ADJ APPROX BCW CAB CLG CONC CONT CJ DIA DWG EGB EA ELEC EQ EQUIP (E) EXT FF GA GALV GC GRND LG MAX MECH MFGR MGB MIN MTL	ABBREVIA ADJUSTABLE APPROXIMATE BARE COPPER WIRE CABINET CEILING CONCRETE CONTINUOUS CONSTRUCTION JOINT DIAMETER DRAWING EQUIPMENT GROUND BAR EACH ELECTRICAL ELEVATION EQUAL EQUIPMENT EXISTING EXTERIOR FINISHED FLOOR GAUGE GALVANIZED GENERAL CONTRACTOR GROUND LONG MAXIMUM MECHANICAL MANUFACTURER MASTER GROUND BAR MINIMUM METAL	N.I.C. NTS O.C. OPP RMC SF SHT SIM SS STL T/C T/M T/S (TYP.) F.V. UNO WWF W/ XMFR BTS PCS PL &	NOT IN CONTRACT NOT TO SCALE ON CENTER OPPOSITE RIGID METAL CONDUIT SQUARE FOOT SHEET SIMILAR STAINLESS STEEL STEEL TOP OF CONCRETE TOP OF MASONRY TOP OF STEEL TYPICAL FIELD VERIFY UNLESS NOTED OTHERWISE WELDED WIRE FABRIC WITH TRANSFORMER BASE TRANSMISSION STATION PERSONAL COMMUNICATIONS SERVICES CENTERLINE PLATE AND AT	ST CHARLES SECTION STATES AND STATE OF STATE OF STATES AND STATES
	EXISTING FENCE WOOD/VIYNL NEW FENCE WOOD/VIYNL NEW SILT FENCE NEW RIGHT OF WAY PROPOSED LEASE AREA PROPOSED ACCESS/UTILITY EASEMENTS EXISTING LEASE AREA EXISTING ACCESS/UTILITY EASEMENTS				CONCRETE EARTH GRAVEL PLYWOOD SAND WOOD CONT. WOOD BLOCKING			A STATE OF THE PARTY OF THE PAR	WILLIAM C. THOMPSON, JR. E-22147 REGISTERED PROFESSIONAL ENGINEER REGISTRATION NUMBER: E-22147	MEXICO & SONDEREN SITE# MO-2014-19 8368 MEXICO RIAD OFALLON, MO 83366 ST. CHARLES COUNTY MONOPOLE SHEET TITLE SYMBOLS & ABBREVIATIONS SHEET NUMBER N-6

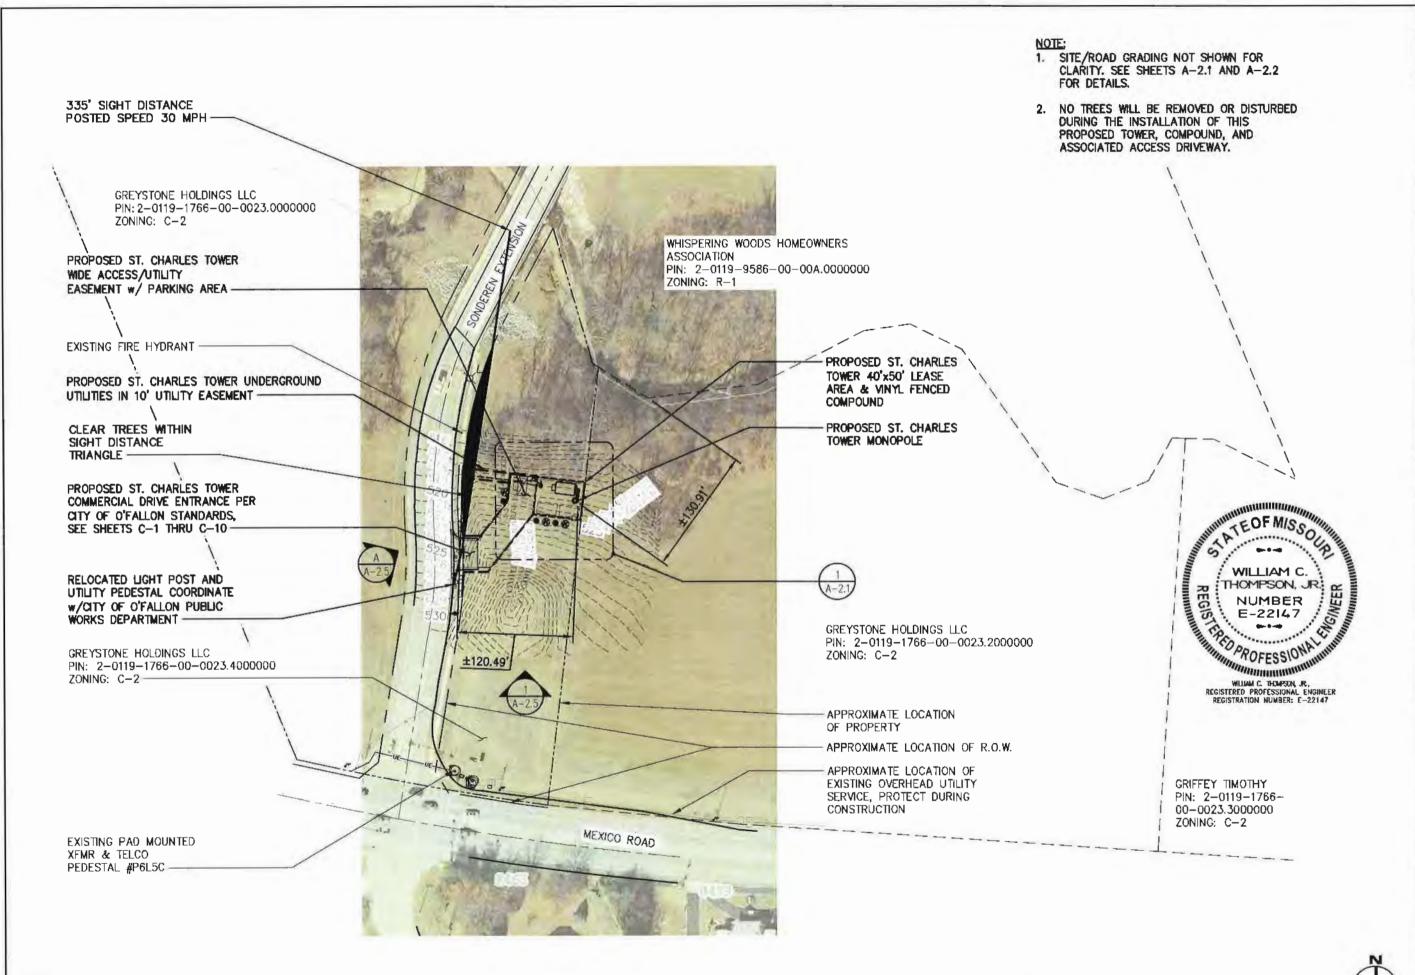

[T] S

PROJECT NO: 8156607 DRAWN BY: JAP

CHECKED BY: JMD

9/23/15 BID/PERMIT

2 11/02/15 CITY COMMENTS 3 11/24/15 ENG REVIEW

MEXICO & SONDEREN


SITE# MO-2014-19


6368 MEXICO ROAD O'FALLON, MO 63366 ST. CHARLES COUNTY

SHEET TITLE

SITE PLAN

MONOPOLE

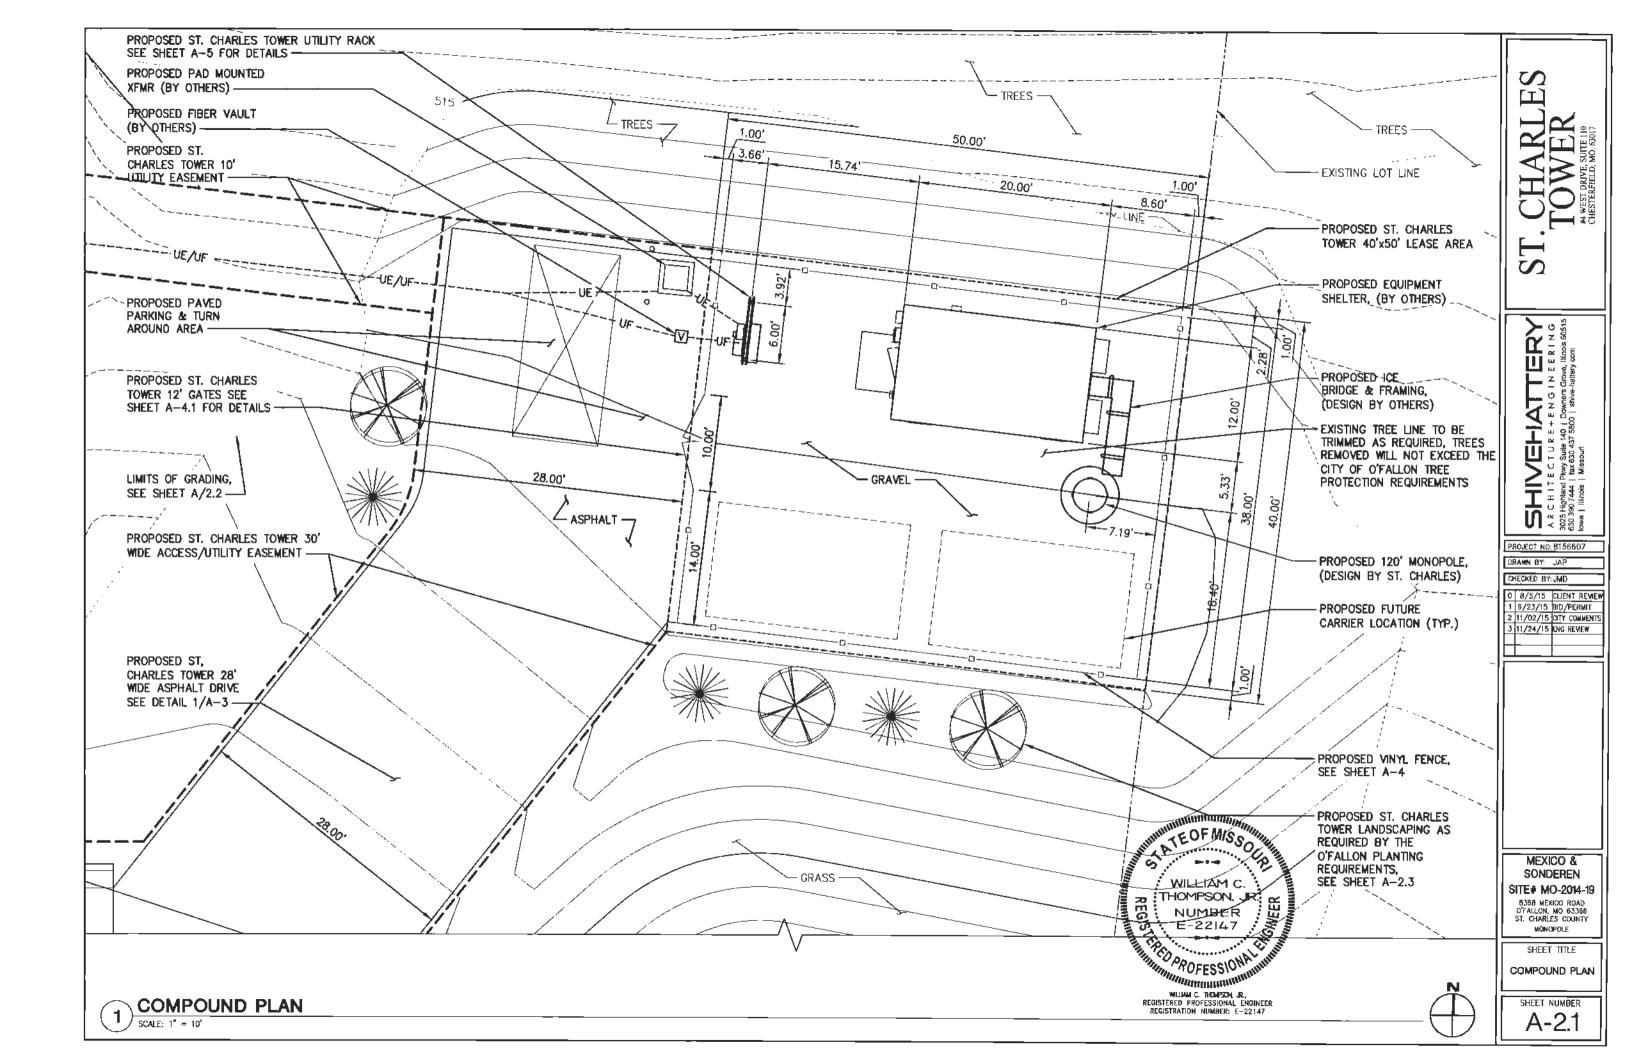

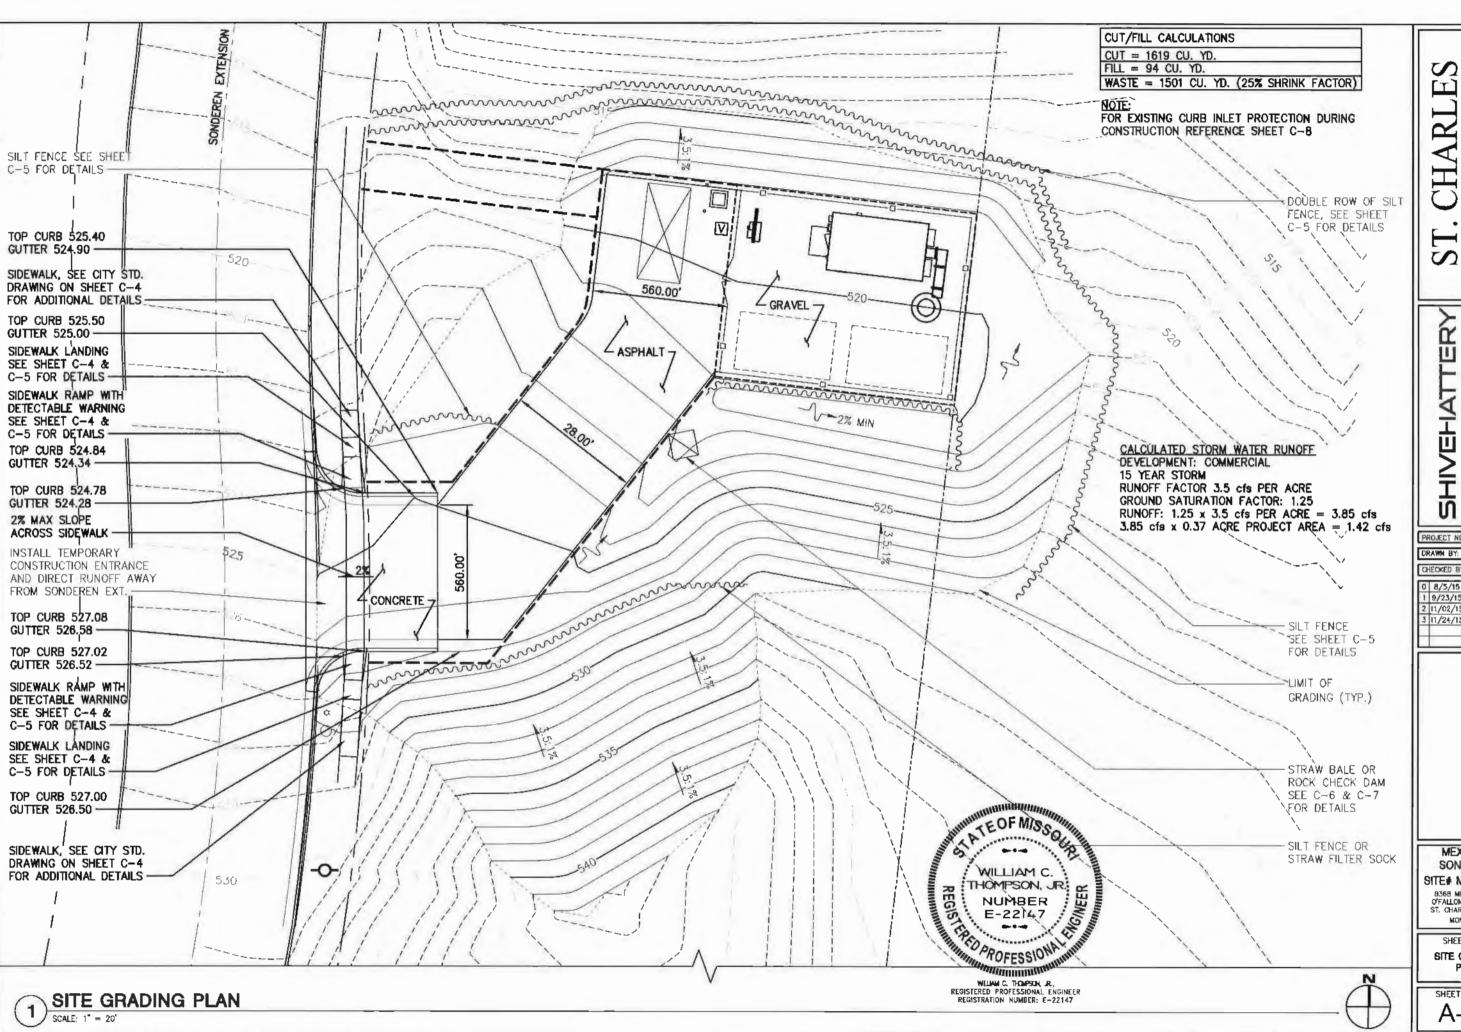

Ľ HARL

III ...

PROJECT NO: 8156607

DRAWN BY: JAP CHECKED BY: JMD

0 8/5/15 CLIENT REVIEW 1 9/23/15 BID/PERMIT 2 11/02/15 CITY COMMENTS 3 11/24/15 ENG REVIEW

MEXICO & SONDEREN

SITE# MO-2014-19

8368 MEXICO ROAD O'FALLON, MO 63366 ST. CHARLES COUNTY MONOPOLE

SHEET TITLE **SITE GRADING** PLAN

LANDSCAPE SCHEDULE					
DESCRIPTION: COMMON NAME	BOTANICAL NAME	MATURE SPREAD	MATURE HEIGHT	QTY.	
COLORADO SPRUCE	PICEA PUNGENS	30'-40'	40'-50'	3	
DOWNY SERVICEBERRY	AMELANCHIER ARBOREA	20'-25'	20'-25'	3	

LANDOGADE LEGENID SH-01-LA-01-001

LANDSCAPE LEGEND							
	TYPE	COMMON NAME					
*	EVERGREEN	COLORADO SPRUCE					
	FLOWERING DECIDUOUS TREE	DOWNY SERVICEBERRY					
SH-01-EA-01-002							

LANDSCAPE NOTES:

SH-01-LA-05-001

- 1. TREES SHOULD BE BALLED AND BURLAPPED. THE USE OF WIRE NURSERY BASKETS IS PROHIBITED.
- 2. CONTACT THE PROPERTY OWNER A MINIMUM OF ONE WEEK PRIOR TO ON-SITE PLANT INSTALLATION, SEE COVER SHEET FOR CONTACT INFORMATION. CITY PERSONAL SHALL FIELD VERIFY LOCATION OF PROPOSED TREES PRIOR TO PLANTING.
- 3. CONTRACTOR SHALL GIVE VERBAL NOTICE TO UTILITY LOCATE. NOT LESS THAN 48 HOURS BEFORE EXCAVATING, EXCLUDING WEEKENDS AND HOLIDAYS.
- 4. SUBSTITUTIONS SHALL BE MADE ONLY WHEN PLANT IS NOT OBTAINABLE, AND THE PROPERTY OWNER, AFTER BEING NOTIFIED IN WRITING, AUTHORIZES A CHANGE ORDER PROVIDING FOR THE NEAREST EQUIVALENT OBTAINABLE SIZE OR VARIETY OF PLANT HAVING THE SAME ESSENTIAL CHARACTERISTICS.
- 5. CONTRACTOR SHALL GUARANTEE PLANT MATERIAL FOR A PERIOD OF TWO YEARS FROM THE DATE OF INITIAL ACCEPTANCE.
- 6. LANDSCAPE CONTRACTOR TO COMPLY WITH REQUIREMENTS OF GOVERNING AGENCIES REGARDING LANDSCAPE REQUIREMENTS.
- 7. MULCH TREES LOCATED OUTSIDE OF DESIGNATED MULCH BEDS WITH A MINIMUM 3" DEPTH CIRCULAR (6-FOOT DIAMETER) OF APPROVED SHREDDED BARK MULCH.



MEXICO & SONDEREN SITE# MO-2014-19 8368 MEXICO ROAD O'FALLON, MO 63366 ST. CHARLES COUNTY

PROJECT NO: 8156607

1 9/23/15 9ID/PERMIT

2 11/02/15 CITY COMMENTS 3 11/24/15 ENG REVIEW


DRAWN BY: JAP

CHECKED BY: JMD 0 8/5/15 CUENT REVIEW


SHEET TITLE LANDSCAPING PLAN & DETAILS

MONOPOLE

SHEET NUMBER A-2.3

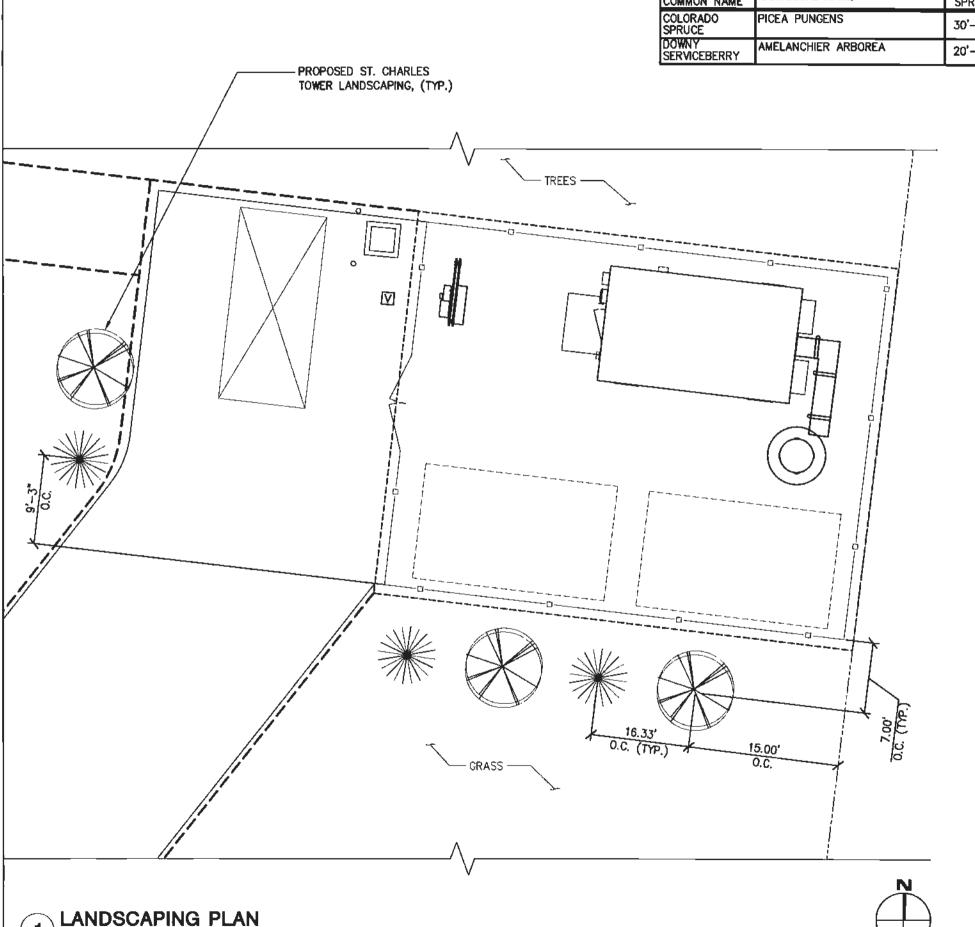


WILLAM C. THEMPSIM, JR., REGISTERED PROFESSIONAL ENGINEER REGISTRATION NUMBER: E-22147

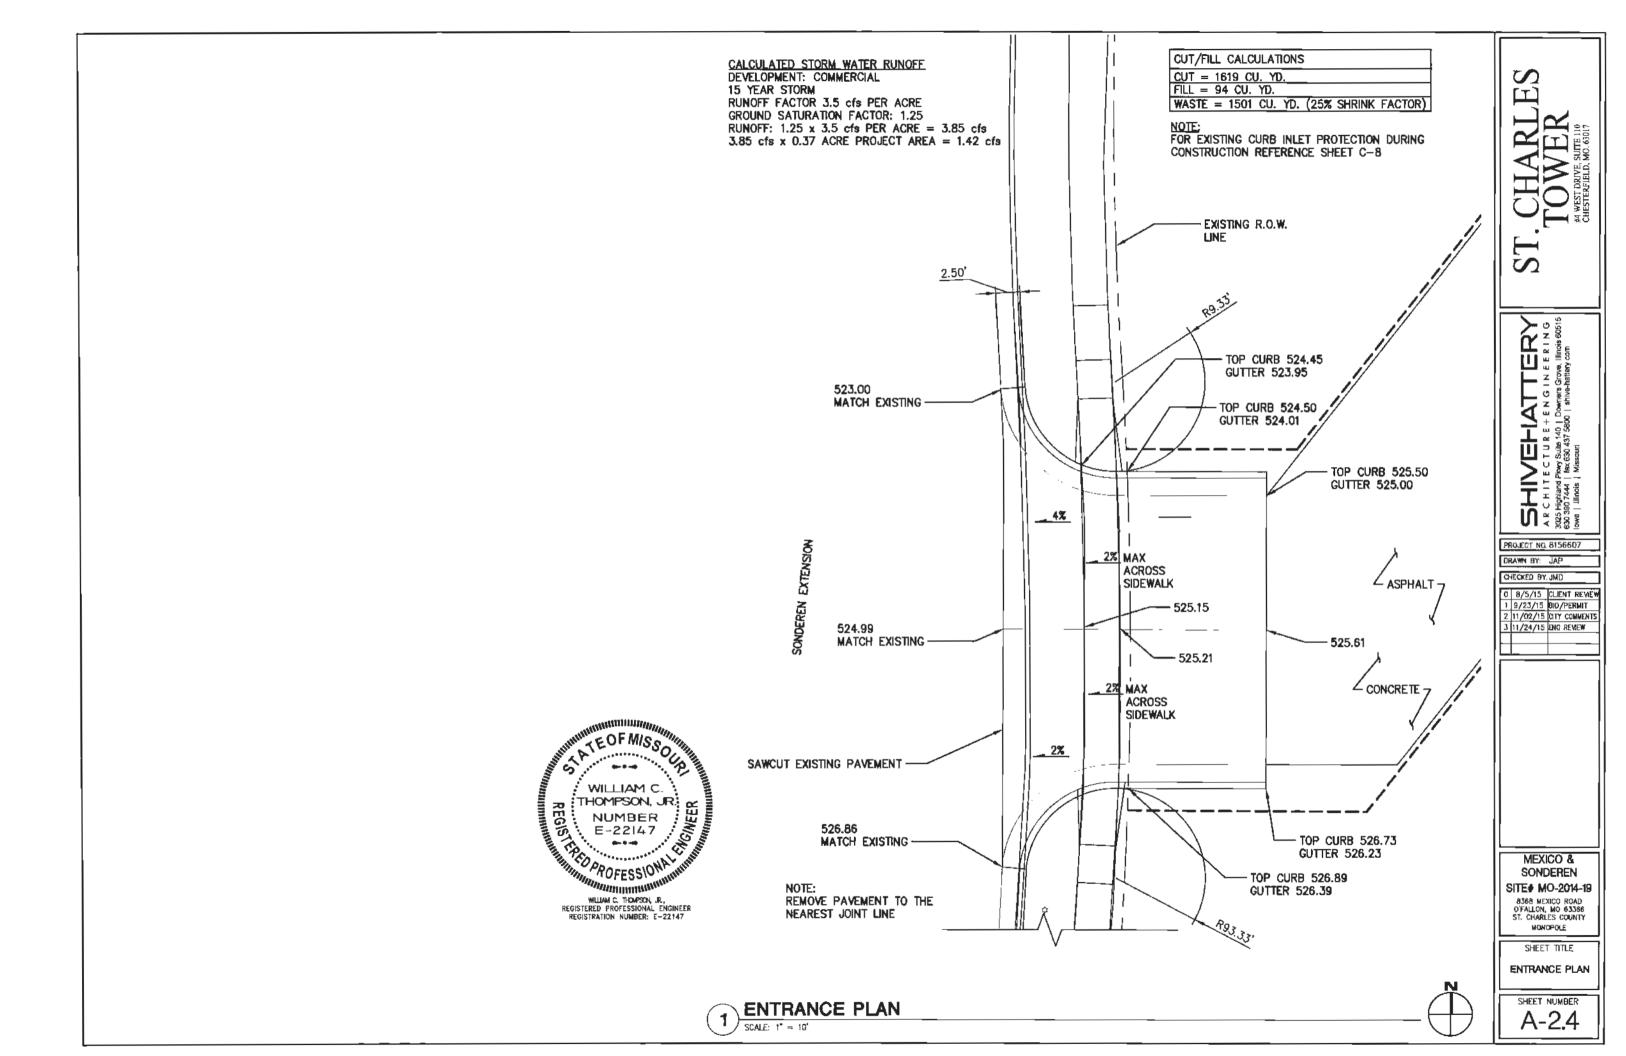

1. ELEVATION IS FOR REFERENCE PURPOSE ONLY.

2. CONTRACTOR SHALL PERFORM WORK DONE TO OR ON STRUCTURE IN ACCORDANCE WITH PROVIDED STRUCTURAL ANALYSIS SEPARATE FROM SHIVE-HATTERY, INC ENGINEERED DRAWINGS.

3. ACTUAL FUTURE CENTERLINES SHALL BE COORDINATED WITH AND APPROVED BY TOWER OWNER. FUTURE ANTENNA AND MOUNTING PLATFORMS MAY NOT BE DEPICTED ON THE ELEVATION.

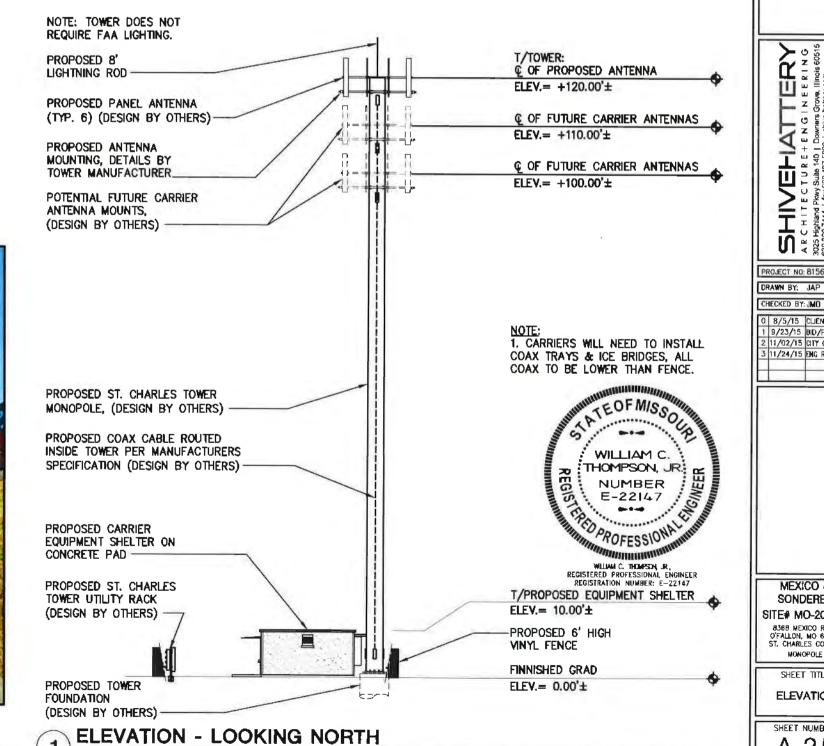



PROPOSED TOWER LOCATION

PROJECT NO: 8156607

9/23/15 BID/PERMIT

2 11/02/15 CITY COMMENTS

11/24/15 ENG REVIEW

CHECKED BY: JMO 0 8/5/15 CLIENT REVIEW

MEXICO & SONDEREN SITE# MO-2014-19

8368 MEXICO ROAD O'FALLON, MO 63366 ST. CHARLES COUNTY MONOPOLE


SHEET TITLE **ELEVATION**

SHEET NUMBER A-2.5

8" BASE ROCK OF 3/4" WITH FINES (ROAD **VARYING** 2" BITUMINOUS SURFACE COURSE -BASE, PROOF ROLL (SEE PLAN A-2.2) PRIOR TO INSTALLATION 2" BITUMINOUS BASE COURSE-OF FINISHED SURFACE SLOPE SLOPE 3.5:1% (TYP.) 3.5:1% (TYP.) SUBGRADE TO BE SCARIFIED TO A REQUIRED DEPTH TO MATCH NEW DRIVE ROAD SHALL BE CLEARED OF ORGANIC MATERIAL OR UNSUITABLE MATERIAL. SUBGRADE MUST BE COMPACTED TO 90% OF STANDARD PROCTOR DENSITY AND VERIFIED BY PROOF-ROLL OR GEOTECH RECOMMENDATIONS.

TYPICAL ACCESS ROAD w/ CULVERT SECTION SCALE: NONE

SH-01-EA-02-005

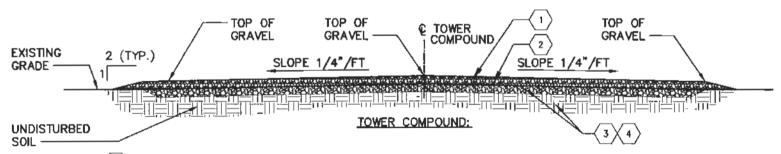

- \langle 1 \rangle 3" of 3/4"-1" minus (chrusher run, fine) rock.
- WEED CONTROL FABRIC MIRAFI 500X, OR APPROVED EQUIVALENT (WHEN SPECIFIED BY PROJECT MANAGER)
- $\left\langle {}_{3}\right\rangle$ 5" Base rock of 3" dia. rock (road base), proof-roll prior to installation of finished gravel.
- SITE SHALL BE CLEARED OF ORGANIC MATERIAL OR UNSUITABLE MATERIAL SUBGRADE MUST BE COMPACTED TO 90% OF STANDARD PROCTOR CENSITY AND VERIFIED BY PROOF-ROLL OR GEOTECHNICAL RECOMMENDATIONS.
- 5. SITES WITH NO FENCE SHALL HAVE AN AREA COVERED WITH WEED BARRIER THAT IS A MINIMUM OF 5 FT WIDE AROUND THE SHELTER AND TOWER AREAS; THIS AREA SHALL BE USABLE AS PARKING SPACE OR FOR STORAGE OF A PORTABLE GENERATOR. LOCAL FIRE CODES MIGHT DICTATE MORE STRINGENT REQUIREMENTS.

6. THE FINISHED GRADE SHALL DIRECT WATER AWAY FROM THE SHELTER.

SH-01-EA-04-001

ATEOF MISSOLA WILLIAM C. REGISTRO PROFESSIONAL THOMPSON, JR. 👱 WILLIAM C. THUMPEN, JR., REGISTERED PROFESSIONAL ENGINEER REGISTRATION NUMBER: E-22147

MEXICO & SONDEREN

PROJECT NO: 8156607 DRAWN BY: JAP CHECKED BY: JMD 0 8/5/15 CLIENT REVIEW 1 9/23/15 BID/PERMIT 2 11/02/15 CITY COMMENTS 3 11/24/15 ENG REVIEW

[T]

S


SITE# MO-2014-19

8368 MEXICO ROAD O'FALLON, MO 63366 ST. CHARLES COUNTY MONOPOLE

SHEET TITLE SITE WORK DETAILS

SHEET NUMBER

TYPICAL COMPOUND CROSS SECTION SCALE: NONE

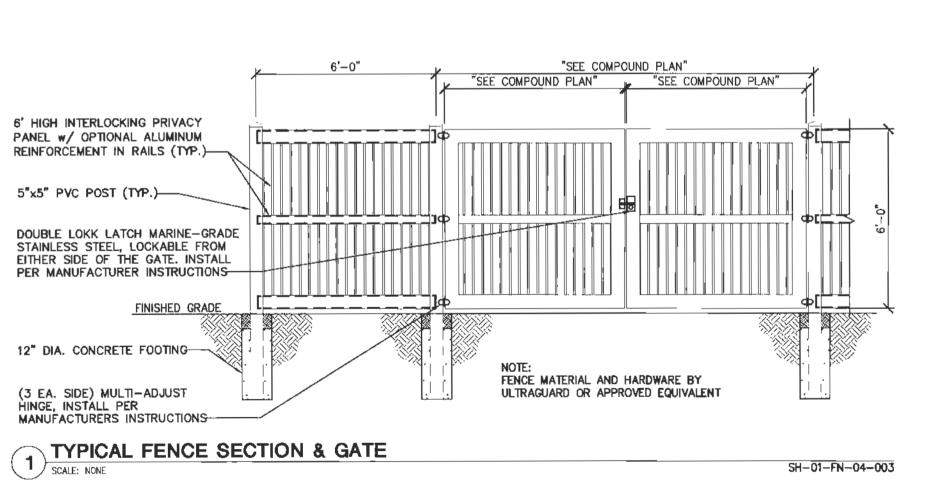

WILLAM C. THOMPSON, JR., REGISTERED PROFESSIONAL ENGINEER REGISTRATION NUMBER: E-22147 -5"x5" PVC POST (TYP.) TOP SOIL CONCRETE FOOTING <u>1'</u>-0"

FENCE POST DETAIL

ST

PROJECT NO: 8156607 DRAWN BY: JAP

WILLIAM C.

SH-01-FN-04-002

CHECKED BY: JMD 0 8/5/15 CLIENT REMEW

1 9/23/15 BIO/PERMIT 2 11/02/15 CITY COMMENTS 3 11/24/15 ENG REMEW

MEXICO & SONDEREN


SITE# MO-2014-19 8366 MEXICO ROAD O'FALLON, MO 63366 ST. CHARLES COUNTY

MONOPOLE

SHEET TITLE FENCE DETAIL

SHEET NUMBER

SCALE: 1/2"=1'-0"

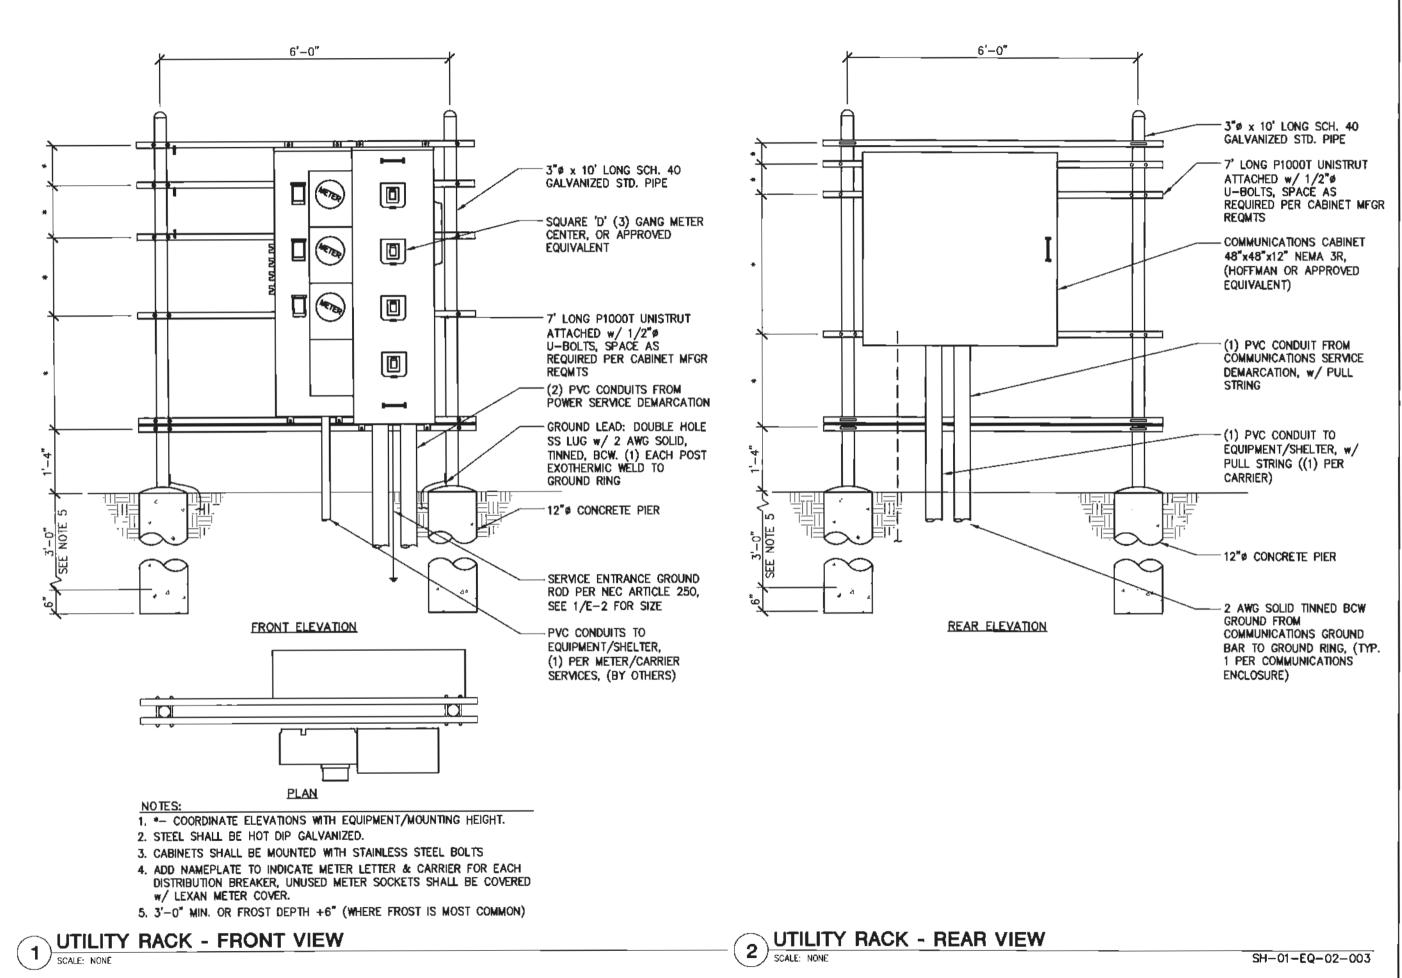

ST. CHARLES
TOWER

HIVERLATTERY
CHITECTURE + ENGINEERING
gibland Powy Suite 140 | Downers Grove, Illinois 605/
0744 | tax 830 437 5800 | shive-hattery com
Illinois | Missouri

PROJECT NO: 8156607

CHECKED BY: JMD

O | 8/5/15 | CLIENT REVIE

0 8/5/15 CLIENT REVIEW
1 9/23/15 BID/PERMIT
2 11/02/15 CITY COMMENTS
3 11/24/15 ENG REVIEW


MEXICO & SONDEREN


SITE# MO-2014-19

8368 MEXICO ROAD O'FALLON, MO 63366 ST. CHARLES COUNTY MONOPOLE

SHEET TITLE

UTILITY RACK DETAILS

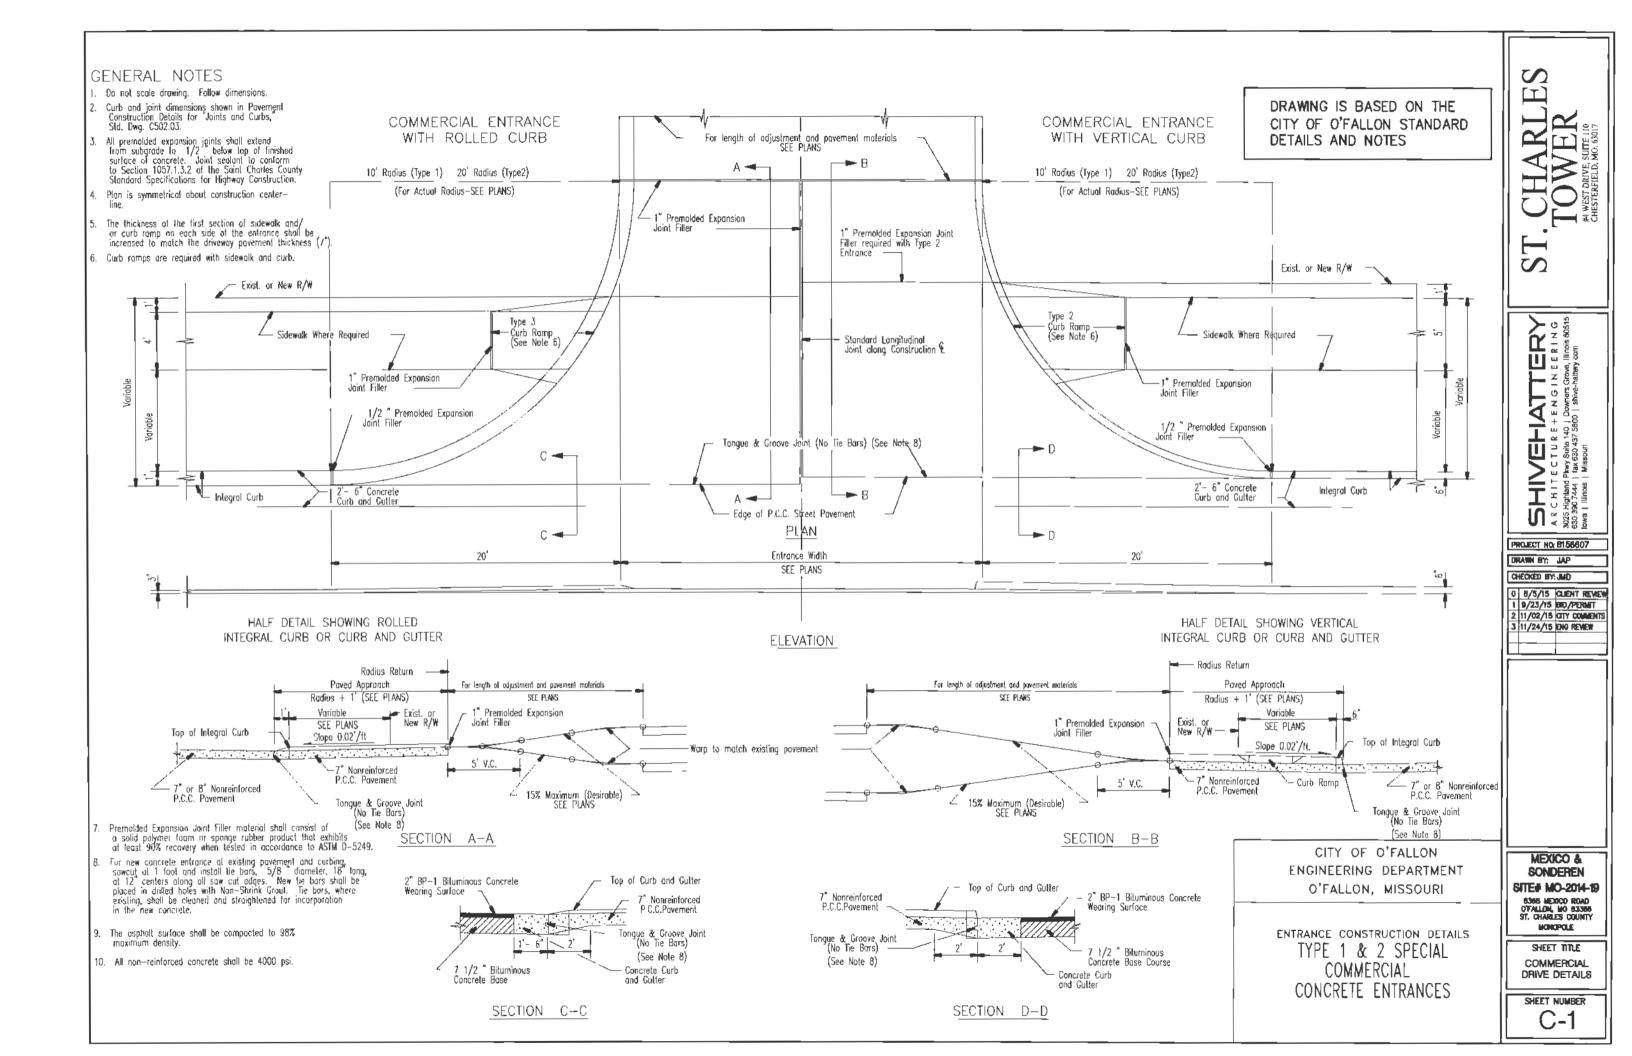

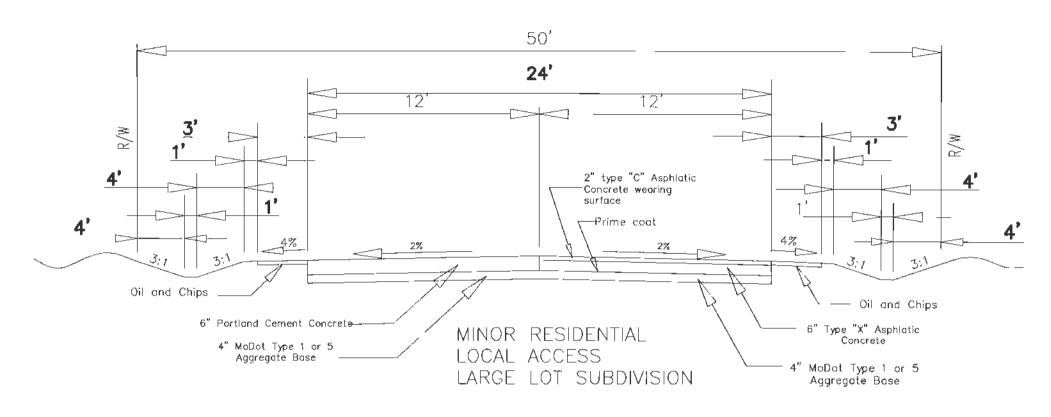

	ROW Width	Pavement Width	Lane Width	No. of Drive Lanes	Utility Easement	Design Speed
Minor Arterial	84	60	12	5	10	40
Collector	60	39	12	3	10	35
Residential Collector	56	32**	N/A	2	10	25
Minor Residential Local Access	50	26	N/A	2	10	25*

Notes: * = Can be varied with City Engineer's approval

** = Detail to match minor residential street with wider pavement

- these requirements may be varied by other City ordinances

— these standards are minimum standards

- Parkway options can be provided as indicated above

Designer will provide roadway cross section and joint locations in a seperate detail drawing.

CITY OF O'FALLON ENGINEERING DEPARTMENT O'FALLON, MISSOURI

Typical Pavement Design

SECTION NO. 405,370

MEXICO & SONDEREN SITE MO-2014-19 8388 MEXICO ROAD O'TALLON MO 83366 ST, CHARLES COUNTY

DRAWN BY: JAP CHECKED BY: JMO


0 8/5/15 CLENT REWEW 1 9/23/15 BID/PERMIT 2 11/02/15 CITY COMMENTS 3 11/24/15 ENG REVIEW

SHEET TITLE
COMMERCIAL

DRIVE DETAILS

SHEET NUMBER

C-2

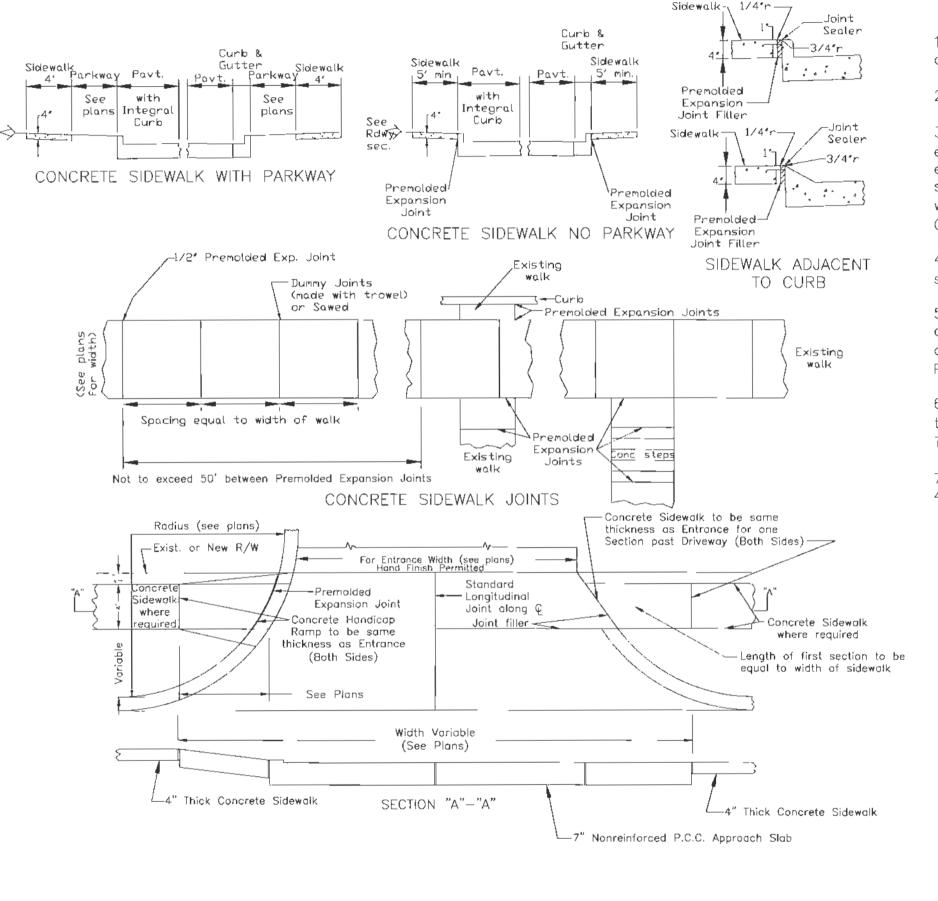

See

Rdwy

sec.

GENERAL NOTES

- 1. Do not scale drawing. Follow dimensions.
- 2. Sidewalk cross slope 0.02'/ft.
- 3. Sidewalk thickness increases to 6" on each side of Private Driveways and 7" on each side of Commercial Driveways for one section of sidewalk equal in length to the width of the sidewalk. See "Entrance Construction Details".
- 4. For sidewalk locations on Cul—De—Sacs see "Pavement Construction Details".
- 5. For longitudinal and transverse joints, dowel, and tie bar requirements and dimensions refer to the "Integral Curb Pavement Typical Sections and Details".
- 6. For roadway cross slopes, pavement types, and thickness, refer to "Standard Typical Section".
- 7. All non-reinforced concrete shall be 4000 psi.

DRAWING IS BASED ON THE CITY OF O'FALLON STANDARD DETAILS AND NOTES

CITY OF O'FALLON ENGINEERING DEPARTMENT O'FALLON, MISSOURI

CONCRETE SIDEWALK
THROUGH
COMMERCAL ENTRANCES

ST. CHARLE TOWER

HITECTURE FENGINEERING
HITECTURE FENGINEERING
Mand Play Suite 140 | Downers Grove, Illinois 60515
744 | Massouri

PROJECT NO. 8156607


CHECKED BYLJAJD

0 8/5/15 CLENT REVIEW 1 9/23/15 90/PERMIT 2 11/02/16 GTY COMMENTS 3 11/24/18 ENG REVIEW

MEXICO & SONDEREN

SITE# MO-2014-19
6368 MEXICO ROAD
OFALLON, NO 63396
57. CHARLES COUNTY
MONOPOLE

SHEET TITLE COMMERCIAL DRIVE DETAILS

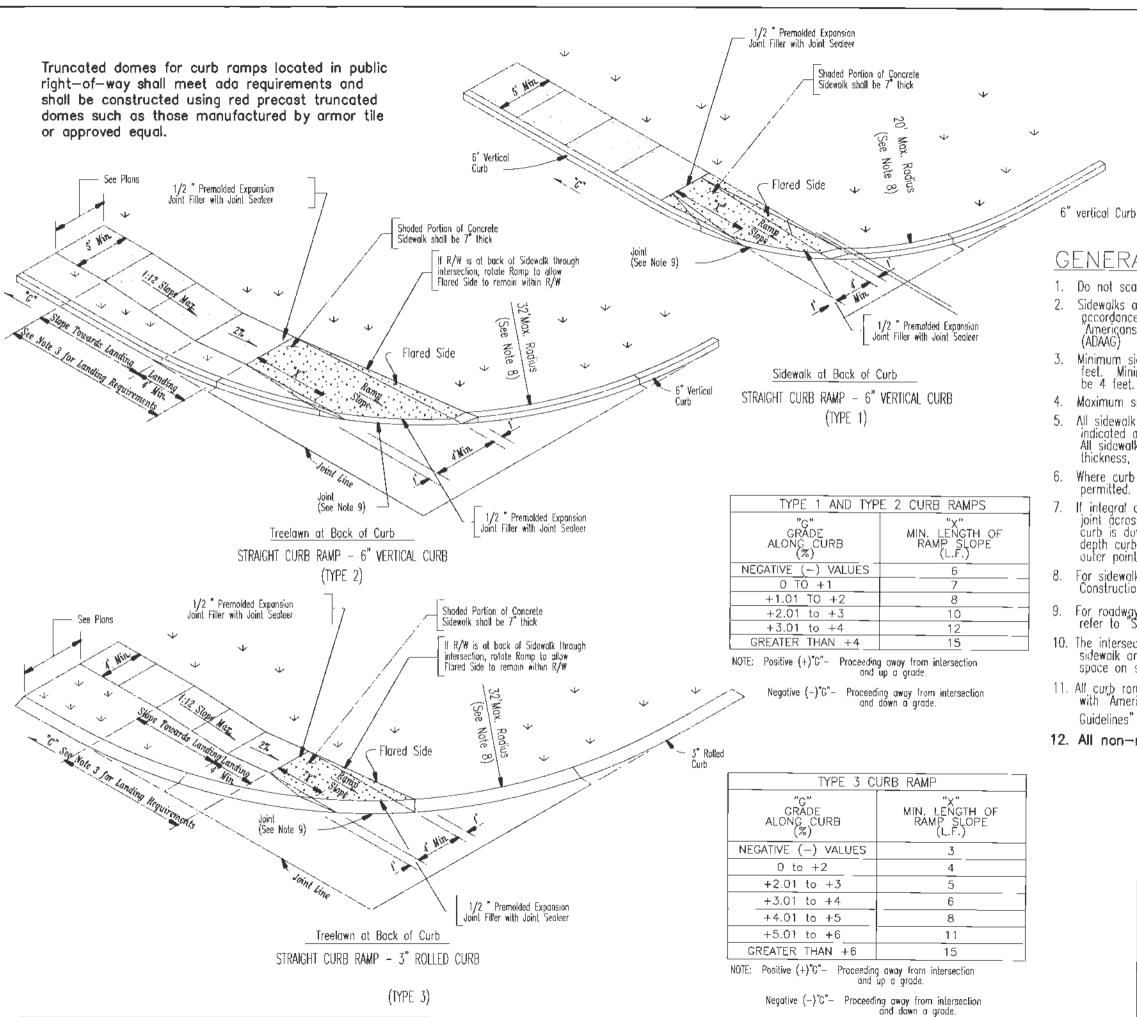

(T)

Ē/)

Ш

T S

Pkwy §

PROJECT NO: 8158607

0 8/5/15 CLIENT REVIEW

1 9/23/15 BID/PERMIT

2 11/02/15 CITY COMMENTS

3 11/24/15 ENG REVIEW

DRAWN BY: JAP

CHECKED 67: JMD

GENERAL NOTES

- 1. Do not scale drawing. Follow dimensions.
- Sidewalks and sidewalk curb ramps shall be constructed in accordance with these details and the current approved "Americans with Disabilities Act Access ibility Guidelines"
- Minimum sidewolk width along 6" vertical curb shall be 5 feet. Minimum sidewalk width along 3" rolled curb shall
- Maximum sidewalk cross slope 0.02'/ft...
- All sidewalk sections shall be 4" thick, except where indicated as 7" thick by shaded portions shown on details. All sidewalk sections and curb ramps, regardless of thickness, shall be paid for as "Concrete Sidewalk".
- Where curb ramp meets pavement, Bullnose will not be permitted.
- If integral concrete curb is constructed, strike a dummy joint across bottom of ramp at curb line. If concrete curb is doweled—on, block out povement to provide full depth curb across ramp from outer point of curb toper to outer point of curb toper.
- For sidewalk locations on Cul—De—Sacs, refer to "Pavement Construction Details".
- For roadway cross slopes, povement types, and thicknesses, refer to "Standard Typical Sections".
- 10. The intersection of two sidewalks or the intersection of a sidewalk and a drivewoy may serve as a wheelchair passing space on sidewalks less than 5 feet wide.
- 11. All curb romps shall have a detectable warning complying with "Americans with Disabilities Act Accessibility Guidelines" (ADAAG)
- 12. All non-reinforced concrete shall be 4000 psi.

CITY OF O'FALLON ENGINEERING DEPARTMENT O'FALLON, MISSOURI

CONCRETE SIDEWALK WITHIN CUL-DE-SACS


SONDEREN SITE# MO-2014-19 8388 MEDICO ROAD O'FALLON, MO 63388 ST. CHARLES COUNTY

COMMERCIAL DRIVE DETAILS

MEXICO &

SHEET TITLE

MONOPOLE

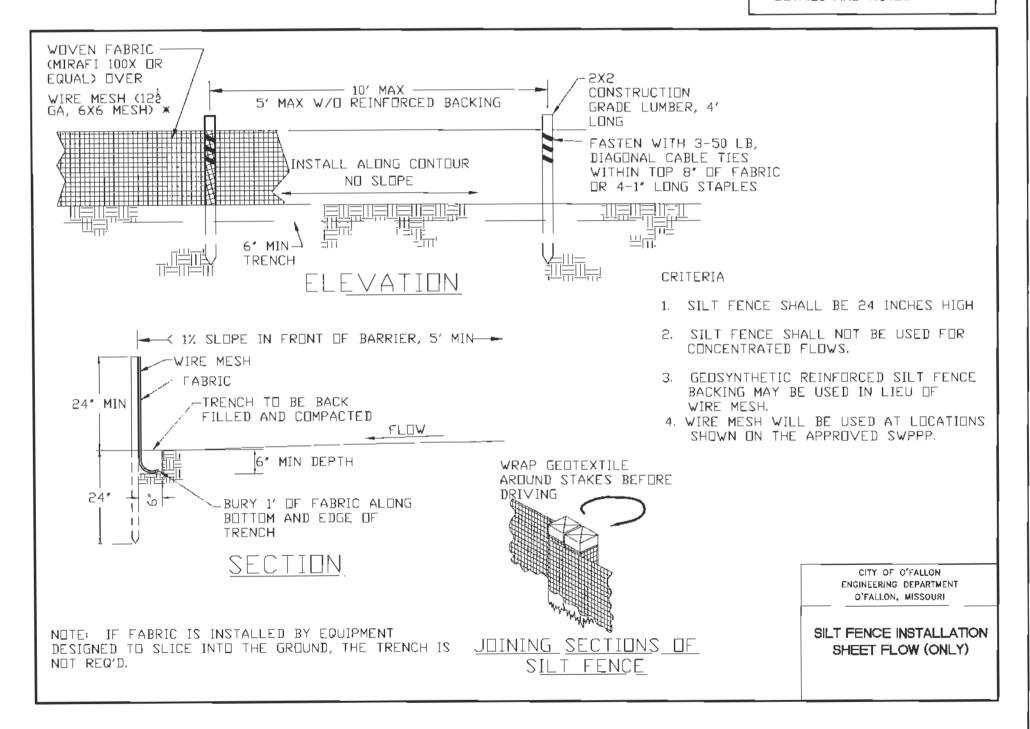

ST. CHARLES
TOWER

SHIVERIATIES OF REFERENCE SHIP OF SHIP

PROJECT NO: 8156807 DRAWN BY: JAP

CHECKED BY: JMD


0 8/5/15 CLIENT REVIEW 1 9/23/15 BIO/PERMIT 2 11/02/15 CITY COMMENTS 3 11/24/15 ENG REVIEW

MEXICO & SONDEREN

SITE# MO-2014-19

8368 MEDICO ROAD
OTALLON, MO B3368
ST. CHARLES COUNTY
MONOPOLE

SHEET TITLE SILT FENCE INSTALLATION

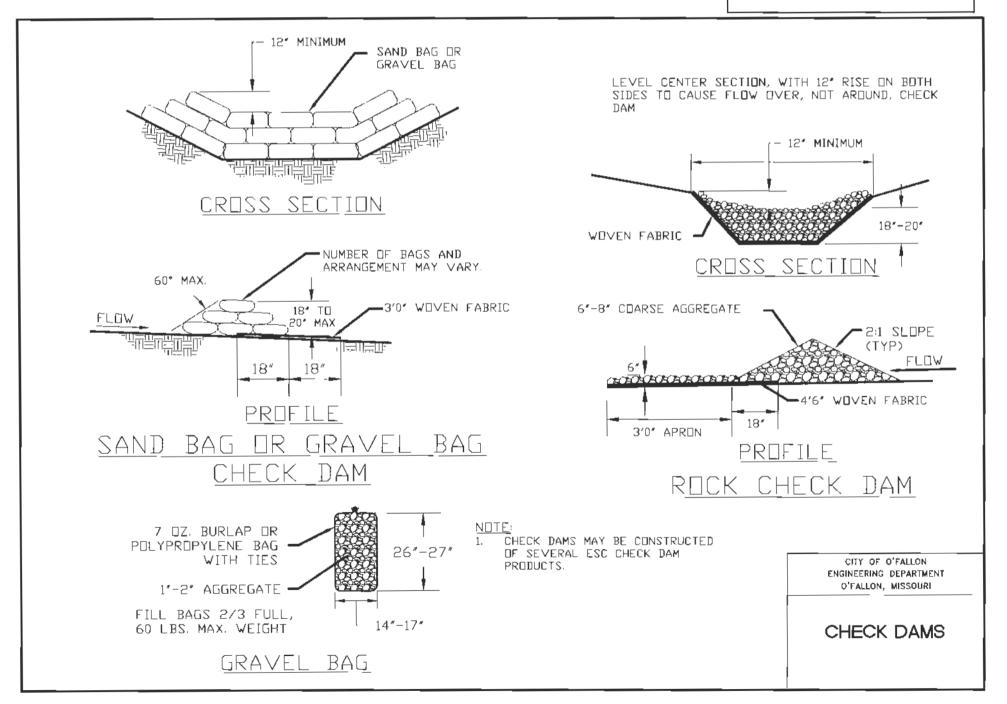

ST. CHARLES
TOWER

BHITECTURE FROINEERING
SE HITECTURE FENGINEERING
SE Highland Pkwy Suite 140 | Downers Grove, Illinois 60515
at Illinois | Missouri

PROJECT NO: 8156607

DRAWN BY: JAP

CHECKED BY: JMD


0 8/5/15 CLIENT REVIEW 1 9/23/15 BID/PERMIT 2 11/02/15 CITY COMMENTS 3 11/24/15 ENG REVIEW

> MEXICO & SONDEREN

SITE# MO-2014-19
8388 MEDICO ROAD
O'FALLON, MO 83388
ST. CHARLES COUNTY

SHEET TITLE

CHECK DAMS

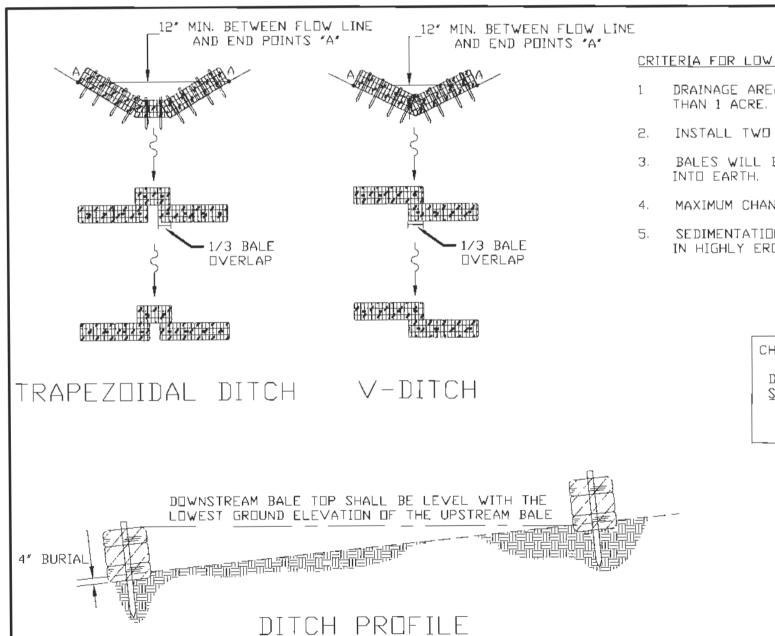

CRITERIA FOR LOW CONCENTRATED FLOWS

DRAINAGE AREAS SHALL BE LESS

INSTALL TWO STAKES PER BALE.

BALES WILL BE TRENCHED 4" DEEP

MAXIMUM CHANNEL SLOPE OF 3%

SEDIMENTATION TRAPS TO BE USED IN HIGHLY EROSIVE AREAS.

CHECK DAM SPACING

Maximum Ditch Slope 3% Spacing 50% 2% 75%

> CITY OF O'FALLON ENGINEERING DEPARTMENT O'FALLON, MISSOURI

STRAW BALE CHECK DAM

S

PROJECT NO: 8156607

DRAWN BY: JAP

CHECKED BY: JMD


1 9/23/15 BID/PERMIT 2 11/02/15 CITY COMMENTS 3 11/24/15 ENG REVIEW

MEXICO & SONDEREN

SITE# MO-2014-19 6368 MEXICO ROAD O'FALLON, MO 63366 ST. CHARLES COUNTY MONOPOLE

SHEET TITLE

CHECK DAMS

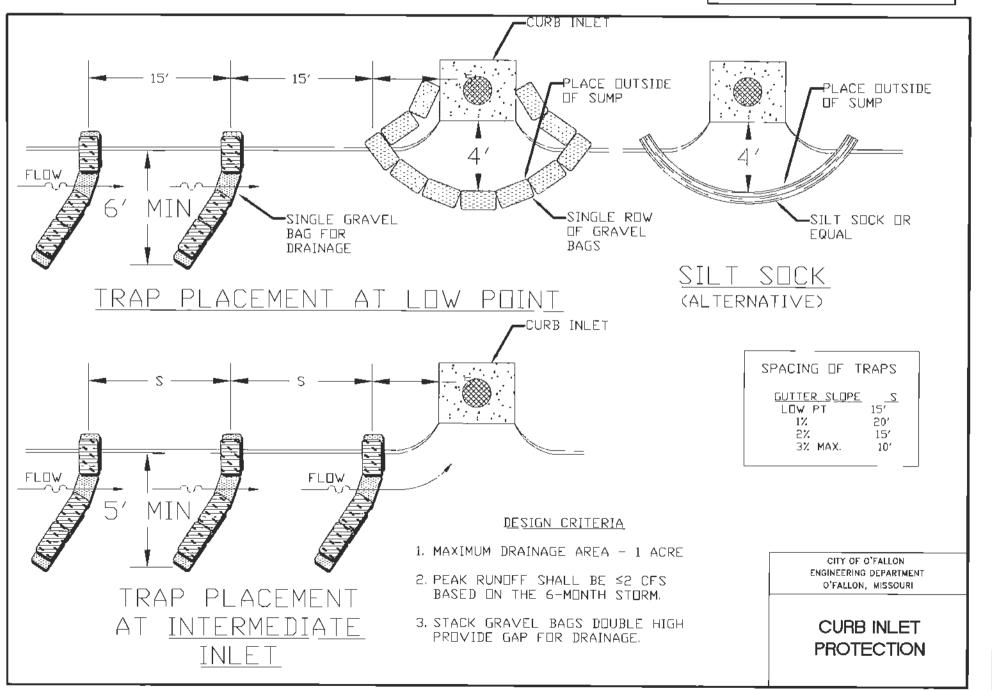

ST. CHARLES
TOWER

HVEHATTERY
ITECTURE FENGINEERING
and Pkwy Suite 140 | Downers Grove, Illnois 6051
44 | Fax 830 437 5900 | shive-hattery com
lois | Missouri

PROJECT NO: 8156607 DRAWN BY: JAP

CHECKED BY: JMD

0 8/5/15 CLIENT REVIEW 1 9/23/15 BID/PERMIT 2 11/02/15 CXTY COMMENTS 3 11/24/15 ENG REVIEW


> MEXICO & SONDEREN

SITE MO-2014-19
6366 MEDIOD ROSS
07ALLON, MO 63366
ST. CHARLES COUNTY
MONOPOLE

SHEET TITLE CURB INLET

PROTECTION

FOR ESC DEVICES

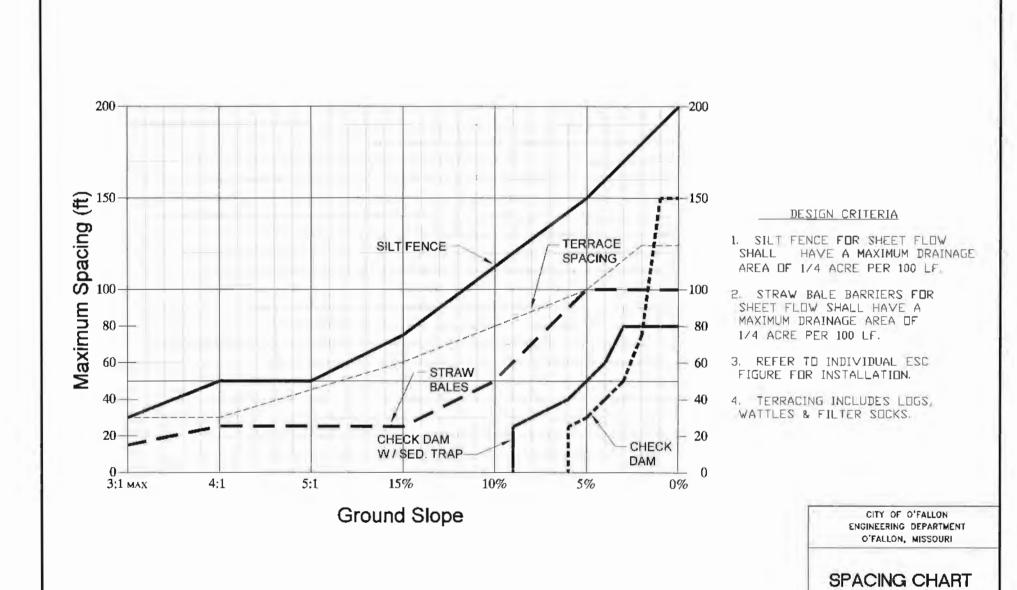

ST. CHARLES
TOWER

HIVEHIATTERY
CHITECTURE + ENGINEERING
Highland Pkwy Suite 140 | Downers Grove, Illinois 60515
Highland Pkwy Sould | Ishive-haffeyy com

PROJECT NO: 81580 DRAWN BY: JAP

CHECKED BY: JMD

0 8/5/15 CLIENT REMEW 1 9/23/15 BID/PERMIT 2 11/02/15 CITY COMMENTS 3 11/24/15 ENG REWEW

MEXICO & SONDEREN

SITE# MO-2014-19

8368 MEDICO ROAD

OFALLON, MO 83366
ST. CHARLES COUNTY

SHEET TITLE SPACING CHART

FOR ESC DEVICES

GENERAL NOTES

- GN #1 DRIVEWAY LOCATIONS SHALL NOT INTERFERE WITH THE SIDEWALK HANDICAP RAMPS, OR CURB INLET SUMPS
- GN #2 SIDEWALKS, CURB RAMPS, RAMPS AND ACCESSIBLE PARKING SPACES SHALL BE CONSTRUCTED IN ACCORDANCE WITH THE CURRENT APPROVED "AMERICAN WITH DISABILITIES ACT ACCESSIBILITY GUIDELINES" (ADAAG) ALONG WITH THE REQUIRED GRADES, CONSTRUCTION MATERIALS, SPECIFICATIONS AND SIGNAGE, IF ANY CONFLICT OCCURS BETWEEN THE ABOVE INFORMATION AND THE PLANS, THE ADAAG GUIDELINES SHALL TAKE PRECEDENCE AND THE CONTRACTOR PRIOR TO ANY CONSTRUCTION SHALL NOTIFY THE PROJECT ENGINEER.
- GN #3 TRUNCATED DOMES FOR CURB RAMPS LOCATED IN PUBLIC RIGHT OF WAY SHALL MEET ADA REQUIREMENTS AND SHALL BE CONSTRUCTED USING RED PRE CAST TRUNCATED DOMES PER PAVEMENT DETAILS.
- GN #4 ANY PROPOSED PAVILIONS OR PLAYGROUND AREAS WILL NEED A SEPARATE PERMIT FROM THE BUILDING DIVISION.
- GN #5 THE CONTRACTOR IS RESPONSIBLE TO CALL MISSOURI ONE CALL AND THE CITY OF O'FALLON FOR THE LOCATION OF UTILITIES. CONTACT THE CITY OF O'FALLON (636) 379-3814 FOR THE LOCATION OF CITY MAINTAINED CABLE FOR STREET LIGHTS AND TRAFFIC SIGNALS, ALL OTHER UTILITIES CALL MISSOURI ONE CALL 1-800-DIG-RITE. 1-800-344-7483
- GN #6 ALL PROPOSED UTILITIES AND/OR UTILITY RELOCATIONS SHALL BE LOCATED UNDERGROUND.
- GN #7 ALL PROPOSED FENCING REQUIRES A SEPARATE PERMIT THROUGH THE BUILDING DIVISION.
- GN #8 ALL CONSTRUCTION OPERATIONS AND WORK ZONE TRAFFIC CONTROL WITHIN THE RIGHT OF WAY WILL FOLLOW MODOT OR M.U.T.C.D. STANDARDS WHICHEVER IS MORE STRINGENT.
- GN #9 ALL FREE STANDING SIGNS SHALL BE LOCATED A MINIMUM OF TEN (10) FEET AWAY FROM ANY RIGHT OF WAY LINE AND/OR PROPERTY LINE AND A MINIMUM OF THREE (3) FEET FROM THE BACK OF CURBING OR SIDEWALK. ALL SIGNS SHALL ABIDE BY THE REGULATIONS FOR VISIBILITY AT CORNERS, INCLUDING CORNERS FROM DRIVEWAYS AND THE STREET IT INTERSECTS PER SECTION 400.260 OF THE O'FALLON ZONING CODE.
- GN #10 ALL SUBDIVISION IDENTIFICATION OR DIRECTIONAL SIGN(S) MUST HAVE THE LOCATIONS AND SIZES APPROVED AND PERMITTED SEPARATELY THROUGH THE PLANNING AND DEVELOPMENT DIVISION.
- GN #11 MATERIALS SUCH AS TREES, ORGANIC DEBRIS, RUBBLE, FOUNDATIONS AND OTHER DELETERIOUS MATERIAL THAT ARE NOT TO BE RE-USED, THEY SHALL BE REMOVED FROM THE SITE AND DISPOSED OF IN COMPLIANCE WITH ALL APPLICABLE LAWS AND REGULATIONS. IF THE MATERIALS LISTED PREVIOUSLY ARE REUSED, A LETTER FROM A SOILS ENGINEER MUST CLARIFY AMOUNT, LOCATION, DEPTH. ECT. AND BE APPROVED WITH THE CONSTRUCTION PLANS. LANDFILL TICKETS FOR SUCH DISPOSAL SHALL BE MAINTAINED ON FILE BY THE DEVELOPER. BURNING ON SITE SHALL BE ALLOWED ONLY BY PERMIT FROM THE LOCAL FIRE DISTRICT. IF A BURN PIT IS PROPOSED THE LOCATION AND MITIGATION SHALL BE SHOWN ON THE GRADING PLAN AND DOCUMENTED BY THE SOILS ENGINEER.
- GN #12 TWENTY-FOUR (24) HOURS PRIOR TO STARTING ANY OF THE WORK COVERED BY THE ABOVE PLANS AND AFTER APPROVAL THEREOF, THE DEVELOPER SHALL MAKE ARRANGEMENTS WITH THE CONSTRUCTION INSPECTION OFFICE TO PROVIDE FOR INSPECTION OF THE WORK, SUFFICIENT IN THE OPINION OF THE CITY ENGINEER, TO ASSURE COMPLIANCE WITH THE PLANS AND SPECIFICATIONS AS APPROVED.
- GN #13 THE CITY ENGINEER OR THEIR DULY AUTHORIZED REPRESENTATIVE SHALL MAKE ALL NECESSARY INSPECTIONS OF CITY INFRASTRUCTURE, ESCROW ITEMS OR INFRASTRUCTURE LOCATED ON THE APPROVED PLANS.

EROSION CONTROL NOTES

- THE PERMITTEE SHALL ASSUME COMPLETE RESPONSIBILITY FOR CONTROLLING ALL SILTATION AND EROSION OF THE PROJECT AREA. THE PERMITTEE SHALL USE WHATEVER MEANS NECESSARY TO CONTROL EROSION AND SILTATION INCLUDING, BUT NOT LIMITED TO, STAKED STRAW BALES AND/DR SILTATION FABRIC FENCES (POSSIBLE METHODS OF CONTROL ARE DETAILED IN THE PLAN). CONTROL SHALL COMMENCE WITH THE CLEARING OPERATIONS AND BE MAINTAINED THROUGHOUT THE PROJECT UNTIL ACCEPTANCE OF THE WORK BY THE CITY OF O'FALLON AND AS NEEDED BY MODOT. THE PERMITTEE'S RESPONSIBILITIES INCLUDE ALL DESIGN AND IMPLEMENTATION AS REQUIRED TO PREVENT EROSION AND THE DEPOSITING OF SILT. THE CITY OF O'FALLON AND AS REQUIRED BY MODOT MAY AT THEIR OPTION DIRECT THE PERMITTEE IN HIS METHODS AS DEEMED FIT TO PROTECT PROPERTY AND IMPROVEMENTS. ANY DEPOSITING OF SILT OR MUD ON NEW OR EXISTING PAVEMENT SHALL BE REMOVED IMMEDIATELY. ANY DEPOSITING OF SILTS OR MUD IN NEW OR EXISTING STORM SEWERS AND/OR SWALES SHALL BE REMOVED AFTER EACH RAIN AND AFFECTED AREAS CLEANED TO THE SATISFACTION OF THE CITY OF O'FALLON AND AS REQUIRED BY MODOT."
- EN #2 ALL EROSION CONTROL SYSTEMS ARE TO BE INSPECTED AND CORRECTED WEEKLY, ESPECIALLY WITHIN 48 HOURS OF ANY RAIN STORM RESULTING IN ONE—HALF INCH OF RAIN OR MORE. ANY SILT OR DEBRIS LEAVING THE SITE AND AFFECTING PUBLIC RIGHT OF WAY OR STORM WATER DRAINAGE FACILITIES SHALL BE CLEANED UP WITHIN 24 HOURS AFTER THE END OF THE STORM.
- EN #3 EROSION CONTROL DEVICES (SILT FENCE, SECIMENT BASIN, ETC.) SHALL BE IN ACCORDANCE WITH ST. CHARLES COUNTY SOIL AND WATER CONSERVATION DISTRICT EROSION AND SEDIMENT CONTROL GUIDELINES.
- THIS DEVELOPMENT IS REQUIRED TO PROVIDE LONG TERM POST CONSTRUCTION BMP'S SUCH AS; LOW IMPACT DESIGN, SOURCE CONTROL AND TREATMENT CONTROLS THAT PROTECTS WATER QUALITY AND CONTROLS RUN OFF TO MAXIMUM EXTENT PRACTICAL IN COMPLIANCE WITH PHASE II ILLICIT STORM WATER DISCHARGE GUIDELINES. (ORD. 5082, SECTION 405.D245)
- EN #5 GRADED AREAS SHALL BE SEEDED AND MULCHED (STRAWED) WITHIN 14 DAYS OF STOPPING LAND DISTURBANCE ACTIVITIES. UNLESS IT CAN BE SHOWN TO THE CITY ENGINEER THAT WEATHER CONDITIONS ARE NOT FAVORABLE, VEGETATIVE GROWTH IS TO BE ESTABLISHED WITHIN 6 WEEKS OF STOPPING GRADING WORK ON THE PROJECT. THE VEGETATIVE GROWTH ESTABLISHED SHALL BE SUFFICIENT TO PREVENT EROSION AND THE STANDARD SHALL BE AS REQUIRED BY EPA AND DNR. (70% COVERAGE PER SQUARE FOOT) ORD. 5242, SECTION 405.070

DRAWING IS BASED ON THE CITY OF O'FALLON STANDARD DETAILS AND NOTES ST. CHARLES
TOWER

HVEFIATTERY
HITECTURE+ENGINEERING
jliand Phay Sulls 140 I Downers Grose, lilincis 60516
A44 I hax 630 437 8900 I sinve-hattery com
linois | Miscouri

PROJECT NO. 8156607

DRAWN BY: JAP CHECKED BY: JMD

0 8/5/15 CLEENT REWEW 1 9/23/15 BID/PERMIT 2 11/02/15 CTY COMMENTS 3 11/24/15 ENG REWEW

MEXICO & SONDEREN

SITE MO-2014-19

8388 MEXICO ROAD
OTALLON, MO 83388
ST. CHARLES COUNTY

SHEET TITLE

GENERAL NOTES

GRADING NOTES

GRN #1 DEVELOPER MUST SUPPLY CITY CONSTRUCTION INSPECTORS WITH AN ENGINEER'S SOILS REPORT PRIOR TO AND DURING SITE GRADING. THE SOIL REPORT WILL BE REQUIRED

TO CONTAIN THE FOLLOWING INFORMATION ON SOIL TEST CURVES (PROCTOR REPORTS) FOR PROJECTS WITHIN THE CITY:

1. MAXIMUM DRY DENSITY.

2. OPTIMUM MOISTURE CONTENT.

3. MAXIMUM AND MINIMUM ALLOWABLE MOISTURE CONTENT.

4. CURVE MUST BE PLOTTED TO SHOW DENSITY FROM A MINIMUM OF 90% COMPACTION AND ABOVE AS DETERMINED BY THE "MODIFIED AASHTO T-180 COMPACTION TEST" (A.S.T.M.-D-1157) OR FROM A MINIMUM OF 95% COMPACTION AND ABOVE AS DETERMINED BY THE "STANDARD PROCTOR TEST AASHTO T-99, METHOD C" (A.S.T.M.-D-698). PROCTOR TYPE MUST BE DESIGNATED ON DOCUMENT.

5. CURVE MUST HAVE AT LEAST 5 DENSITY POINTS WITH MOISTURE CONTENT AND SAMPLE LOCATIONS LISTED ON DOCUMENT.

6. SPECIFIC GRAVITY.

7. NATURAL MOISTURE CONTENT.

8. LIQUID LIMIT.

9. PLASTIC LIMIT.

BE ADVISED THAT IF THIS INFORMATION IS NOT PROVIDED TO THE CITY'S CONSTRUCTION INSPECTOR THE CITY WILL NOT ALLOW GRADING OR CONSTRUCTION ACTIVITIES TO PROCEED ON ANY PROJECT SITE.

- GRN #2 ALL FILL PLACED IN AREAS OTHER THAN PROPOSED STORM SEWERS, SANITARY SEWERS, PROPOSED ROADS, AND PAVED AREAS SHALL BE COMPACTED FROM THE BOTTOM OF THE FILL UP IN 8" LIFTS AND COMPACTED TO 90% MAXIMUM DENSITY AS DETERMINED BY MODIFIED AASHTO T-180 COMPACTION TEST OR 95% OF MAXIMUM DENSITY AS DETERMINED BY THE STANDARD PROCTOR TEST AASHTO T-99. ENSURE THE MOISTURE CONTENT OF THE SOIL IN FILL AREAS CORRESPONDS TO THE COMPACTIVE EFFORT AS DEFINED BY THE STANDARD OR MODIFIED PROCTOR TEST. OPTIMUM MOISTURE CONTENT SHALL BE DETERMINED USING THE SAME TEST THAT WAS USED FOR COMPACTION. SOIL COMPACTION CURVES SHALL BE SUBMITTED TO THE CITY OF O'FALLON PRIOR TO THE PLACEMENT OF FILL.
- GRN #3 THE SURFACE OF THE FILL SHALL BE FINISHED SO IT WILL NOT IMPOUND WATER. IF AT THE END OF A DAYS WORK IT WOULD APPEAR THAT THERE MAY BE RAIN PRIOR TO THE NEXT WORKING DAY, THE SURFACE SHALL BE FINISHED SMOOTH. IF THE SURFACE HAS BEEN FINISHED SMOOTH FOR ANY REASON, IT SHALL BE SCARIFIED BEFORE PROCEEDING WITH THE PLACEMENT OF SUCCEEDING LIFTS. FILL SHALL NOT BE PLACED ON FROZEN GROUND, NOR SHALL FILLING OPERATIONS CONTINUE WHEN THE TEMPERATURE IS SUCH AS TO PERMIT THE LAYER UNDER PLACEMENT TO FREEZE.
- GRN #4 ALL SEDIMENT AND DETENTION BASINS ARE TO BE CONSTRUCTED DURING THE INITIAL PHASE OF THE GRADING OPERATION OR IN ACCORDANCE WITH THE APPROVED SWPPP.
- GRN #5 WHEN GRADING OPERATIONS ARE COMPLETE OR SUSPENDED FOR MORE THAN 14 DAYS, PERMANENT GRASS MUST BE ESTABLISHED AT SUFFICIENT DENSITY TO PROVIDE EROSION CONTROL ON SITE. BETWEEN PERMANENT GRASS SEEDING PERIODS, TEMPORARY COVER SHALL BE PROVIDED ACCORDING TO ST. CHARLES SOIL AND WATER CONSERVATION DISTRICT MODEL SEDIMENT AND EROSION CONTROL REGULATIONS. ALL FINISHED GRADES (AREAS NOT TO BE DISTURBED BY IMPROVEMENTS) IN EXCESS OF 20% SLOPES (5:1) SHALL BE MULCHED AND TACKED AT A RATE OF 100 POUNDS PER 1000 SQUARE FEET WHEN SEEDED.
- GRN #6 NO SLOPES SHALL EXCEED 3 (HORIZONTAL): 1 (VERTICAL) UNLESS OTHERWISE APPROVED BY THE SOILS REPORT AND SPECIFICALLY LOCATED ON THE PLANS AND APPROVED BY THE CITY ENGINEER.
- GRN #7 ALL LOW PLACES WHETHER ON SITE OR OFF SHALL BE GRADED TO PROVIDE DRAINAGE WITH TEMPORARY DITCHES.
- GRN #8 ALL EXISTING WELLS ON SITE SHALL BE CAPPED PER DNR STANDARDS.
- GRN #10 ALL TRENCH BACK FILLS UNDER PAVED AREAS SHALL BE GRANULAR BACK FILL, AND COMPACTED MECHANICALLY. ALL OTHER TRENCH BACK FILLS MAY BE EARTH MATERIAL (FREE OF LARGE CLODS, OR STONES) AND COMPACTED USING EITHER MECHANICAL OR WATER JETTING, GRANULAR MATERIAL AND EARTH MATERIAL ASSOCIATED WITH NEW CONSTRUCTION OUTSIDE OF PAVEMENTS MAY BE JETTED, TAKING CARE TO AVOID DAMAGE TO NEWLY LAID SEWERS. THE JETTING SHALL BE PERFORMED WITH A PROBE ROUTE ON NOT GREATER THAN 7.5 FOOT CENTERS WITH THE JETTING PROBE CENTERED OVER AND PARALLEL WITH THE DIRECTION OF THE PIPE. TRENCH WIDTHS GREATER THAN 10 FEET WILL REQUIRE MULTIPLE PROBES EVERY 7.5 FOOT CENTERS.
 - A) DEPTH, TRENCH BACK FILLS LESS THAN 8 FEET DEEP SHALL BE PROBED TO A DEPTH EXTENDING HALF THE DEPTH OF THE TRENCH BACK FILL, BUT NOT LESS
 THAN 3 FEET. TRENCH BACK FILL GREATER THAN 8 FEET IN DEPTH SHALL BE PROBED TO HALF THE DEPTH OF THE TRENCH BACK FILL BUT NOT GREATER THAN B
 FFET
 - B) EQUIPMENT, THE JETTING PROBE SHALL BE A METAL PIPE WITH AN INTERIOR DIAMETER OF 1.5 TO 2 INCHES.
 - C) METHOD, JETTING SHALL BE PERFORMED FROM THE LOWEST SURFACE TOPOGRAPHIC POINT AND PROCEED TOWARD THE HIGHEST POINT, AND FROM THE BOTTOM OF THE TRENCH BACK FILL TOWARD THE SURFACE. THE FLOODING OF EACH JETTING PROBE SHALL BE STARTED SLOWLY ALLOWING SLOW SATURATION OF THE SOIL. WATER IS NOT ALLOWED TO FLOW AWAY FROM THE TRENCH WITHOUT FIRST SATURATING THE TRENCH.
 - D) SURFACE BRIDGING, THE CONTRACTOR SHALL IDENTIFY THE LOCATIONS OF THE SURFACE BRIDGING (THE TENDENCY FOR THE UPPER SURFACE TO CRUST AND ARCH OVER THE TRENCH RATHER THAN COLLAPSE AND CONSOLIDATE DURING THE JETTING PROCESS). THE CONTRACTOR SHALL BREAK DOWN THE BRIDGED AREAS USING AN APPROPRIATE METHOD SUCH AS WHEELS OR BUCKET OF A BACKHOE. WHEN SURFACE CRUST IS COLLAPSED, THE VOID SHALL BE BACK FILLED WITH THE SAME MATERIAL USED AS TRENCH BACK FILL AND REJETTED. COMPACTION OF THE MATERIALS WITHIN THE SUNKEN/JETTED AREA SHALL BE COMPACTED SUCH THAT NO FURTHER SURFACE SUBSIDENCE OCCURS.

GRN #11 SITE GRADING.

- A. WITHIN CITY RIGHT-OF-WAY. MATERIAL IS TO BE PLACED IN EIGHT (8) INCH TO TWELVE (12) INCH LOOSE LIFTS AND COMPACTED PER THE APPROVED COMPACTION REQUIREMENTS. ONE (1) COMPACTION TEST WILL BE PERFORMED EVERY TWO HUNDRED FIFTY (250) FEET ALONG THE CENTERLINE FOR EACH LIFT.
- B. OUTSIDE OF CITY RIGHT-OF-WAY. MATERIAL IS TO BE PLACED IN EIGHT (8) INCH TO TWELVE (12) INCH LOOSE LIFTS AND COMPACTED PER THE APPROVED COMPACTION REQUIREMENTS. ONE (1) COMPACTION TEST WILL BE PERFORMED AT TWO (2) FOOT VERTICAL INTERVALS AND APPROXIMATELY EVERY ONE THOUSAND (1,000) CUBIC YARDS.

DRAWING IS BASED ON THE CITY OF O'FALLON STANDARD DETAILS AND NOTES ST. CHARLES TOWER

IVEPLATTERY
ITECTURE FER GINE ERING
and Play Suite 140 I Downers Grove, Illinois 60515
A | tax 60437 9800 | shive-hattery com

PROJECT NO: 8158607 DRAWN BY: JAP

CHECOGED BY MID

0 8/5/15 CLIENT REVIEW 1 9/23/15 BID/PERMIT 2 11/02/15 CITY COMMENTS 3 11/24/15 ENG REVIEW

> MEXICO & SONDEREN

SITE# MO-2014-19 8388 MEDICO ROAD OFFALLON, MO 63366 ST. GHARLES COUNTY

MONOPOLE

SHEET TITLE GENERAL NOTES

SERVICE KEY NOTES:

- ELECTRICAL SERVICE FROM DEMARCATION TO PROPOSED XFRM
 LENGTH 75'-0" ±:

 (2) SETS OF (3) 350 KCMIL CU IN (2) 4" SCH. 40 PVC OR
 DIRECT BURY BY UTILITY COMPANY, COORDINATE w/ LOCAL
 UTILITY COMPANY,
- COMMUNICATIONS SERVICE FROM DEMARCATION TO VAULT LENGTH 75'-0"± (FIELD VERIFY LOCATION);
 (1) 4" SCH. 40 PVC w/MULE TAPE, 1-1/4" INNER DUCT & PULL STRING.



CAP & STAKE PROPOSED UTILITY CONDITIONS & R.O.W. (TYP.), COORDINATE SERVICE W/LOCAL UTILITY COMPANY MARTIN VALENTINE, PROFESSIONAL ENGINEER REGISTRATION MARKER: 2007005050 PROPOSED ST. CHARLES TOWER UTILITY RACK, SEE SHEET A-5 FOR DETAILS - GRAVEL **GRASS** -GRASS

MEXICO & SONDEREN

PROJECT NO: 8156607

DRAWN BY: JAP

CHECKED BY: JMD

0 8/5/15 CLIENT REVIEW
1 9/23/15 BID/PERMIT
2 11/02/15 CITY COMMENTS
3 11/24/15 ENG REVIEW

S

SITE# MO-2014-19

8368 MEXICO ROAD O'FALLON, MO 63366 ST. CHARLES COUNTY MONOPOLE

SHEET TITLE
UTILITY PARTIAL

SITE PLAN

SHEET NUMBER

TUTILITY PARTIAL SITE PLAN

1" = 10'

SERVICE NOTES:

- SERVICE POWER SHALL BE (120/240VAC, 600A, 10, 3W) OR (120/208VAC, 600A, 10,3W).
 A 600 AMP, 120/240V, 10 METER RACK SHALL BE INSTALLED WHERE IT IS ACCESSIBLE FOR READOUT. THE NUMBER OF JAWS IN THE METER SOCKET AND THEIR ARRANGEMENT WILL DEPEND ON THE VOLTAGE SERVICE.
- CABLE SIZES SHALL BE ADJUSTED TO COMPENSATE FOR VOLTAGE DROP IF LONGER THAN 180FT. VERIFY CONDUIT SIZE WHEN CHANGING CABLE SIZE.
- 4. FOR COMPLETE INTERNAL WIRING AND ARRANGEMENT REFER TO VENDOR PRINTS PROVIDED BY MANUFACTURER.
- 5. CONDUITS ROUTED BELOW GRADE NEAR ACCESS DRIVE OR WITH/IN COMPOUND SHALL BE SCHEDULE 40 PVC (U.N.O.).

ELECTRICAL SERVICE KEY NOTES:

- (FUTURE CONDUIT DESIGNED AND INSTALLED BY OTHERS)
- (FUTURE CONDUIT DESIGNED AND INSTALLED BY OTHERS)
- 3 2/A-5 UTILITY RACK, SEE DETAIL, 1 &
- NEMA-3R, COMMUNICATION
 CABINET MOUNTED TO UTILITY
 RACK
- 2 AWG SOLID TINNED BCW FROM COMMUNICATION CABINET GROUND BUS TO GROUND RING
- 6 3/0 AWG SOLID TINNED BCW -
- 5/8" x10'-0" LG COPPER
 CLAD STEEL GROUND ROD,
 GROUND RESISTANCE NOT TO
 EXCEED 5 OHMS.

SCALE: NONE


- (8) COMPOUND FENCE
- 9 PAD MOUNTED TRANSFORMER (BY UTILITY PROVIDER)
- SECONDARY CONDUCTORS:

 (3) 350 KCMIL CU IN (2) 4"
 SCH. 40 PYC OR DIRECT BURY
 BY UTILITY COMPANY,
 COORDINATE w/ LOCAL UTILITY
 COMPANY
- (1) 4" SCH. 40 PVC BETWEEN
 COMMUNICATIONS BOX AND
 VAULT W/ COMMUNICATIONS
 SERVICE CABLES & PULL STRING

- PROVIDE PULL CORD CAP & STAKE CONDUIT AT EDGE OF R.O.W./PROPERTY LINE
- SERVICE RATED 200A MAIN DISCONNECT & UTILITY COMPANY APPROVED METER IN, MULTI-GANG METER CENTER. 600A, 120/240V, 1 PHASE, NEMA 3R
- (BY OTHERS)
- NOT USED
- COMMUNICATION SERVICE
 CONDUIT BY COMMUNICATION
 PROVIDER

GENERAL NOTES:

- 1. THIS DRAWING IS A SCHEMATIC ONLY.
- SEE COMPOUND PLAN FOR EXACT EQUIPMENT LOCATION.
- STUB CONDUITS 6" ABOVE FINISHED GRADE/SLAB, PROVIDE PULL CORD, & CAP CONDUIT. DUCT TAPE IS NOT ALLOWED FOR CAPPING.
- 4. PROVIDE LONG SWEEPS FIBERGLASS ELBOW.

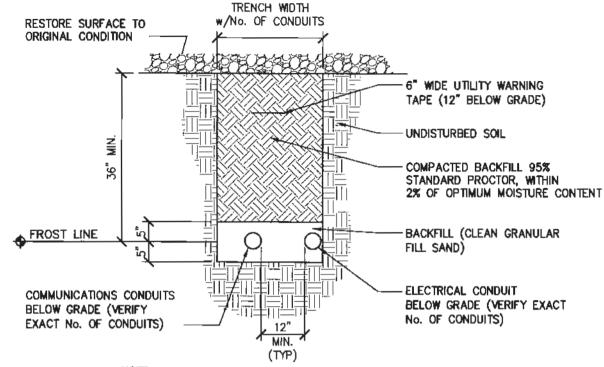


COORDINATE

NOTE:

1. SEPARATION DIMENSION TO BE VERIFIED WITH LOCAL
UTILITY COMPANY REQUIREMENTS

JOINT TRENCH ELECTRIC/COMMUNICATIONS

SH-01-EL-02-001

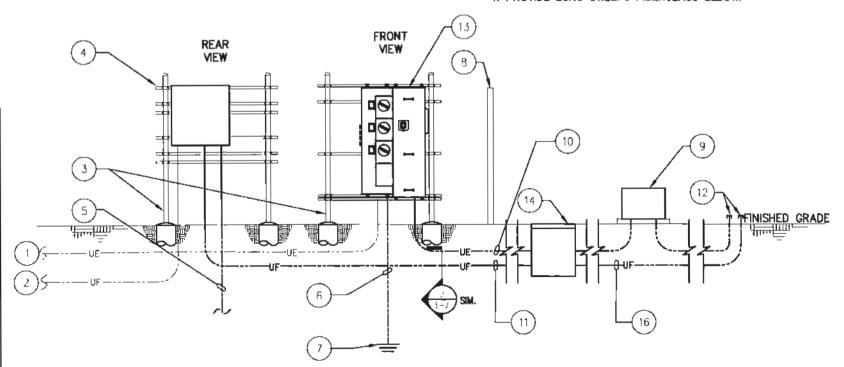

UNDERGROUND UTILITY SERVICE ENTRANCE - (TYP.)



MEXICO & SONDEREN
SITE# MO-2014-19
8368 MEDICO ROMO
OFFALION, MO 83369
ST. CHARLES COUNTY

PROJECT NO: 8156607

0 8/5/15 CLIENT REVIEW 1 9/23/15 BID/PERMIT 2 11/02/15 CITY COMMENTS

3 11/24/15 ENG REVIEW

DRAWN BY: JAP

CHECKED BY: JMD

L

S

民国

SHEET TITLE
UTILITY SERVICE
ENTRANCE

SCHEMATIC SHEET NUMBER

SH-01-EL-01-014

SCALE: NONE

SITE# MO-2014-19

8368 MEXICO ROAD O'FALLON, MO 63366 ST. CHARLES COUNTY MONOPOLE

> SHEET TITLE COMPOUND GROUNDING PLAN

SHEET NUMBER E-3



NOTES:

MAY VARY.

TO THE GROUND RING.

MARTIN VALENTINE:

2007005050

1. GROUND WIRES ARE 2 AWG SOLID TINNED BCW U.N.O.

2. GROUND RING/RODS SHALL BE 30" BELOW FINISHED GRADE OR 6" BELOW FROST DEPTH, WHICHEVER IS DEEPER, DEPTH

3. METALS WITHIN 6' OF THE GROUND RING SHALL BE BONDED

4. EXOTHERMIC WELD, 2 AWG SOLID TINNED BCW, @ TOWER

BASE PLATE. CONNECT TO TOWER GROUND RING W/

5. THIS DRAWING IS FOR SCHEMATIC PURPOSES ONLY THE

EXOTHERMIC WELD (TYP. 3 PLACES.)

EXOTHERMIC WELD CONNECTION (TYP.)

5/8"x10'-0" LONG COPPER CLAD STEEL GROUND ROD 9 10' O.C. (TYP.)

MARTIN VALENTING, PROFESSIONAL ENGINEER REGISTRATION MUMBER: 2007005050

5/8"x10" LONG COPPER CLAD STEEL GROUND EXACT LAYOUT AND ORIENTATION OF TOWER AND EQUIPMENT ROD, UTILITY GROUND MAY VARY, SEE COMPOUND PLAN FOR EXACT PLACEMENT. 6. GROUNDING OF FUTURE SHELTER, ICE BRIDGE & GENERATOR ARE BY OTHERS. V EQUIPMENT SHELTER GROUND SYSTEM, (DESIGN BY OTHERS) 2 AWG SOLID TINNED BCW GROUND RING, MIN. 30" BELOW GRADE, SEE NOTE

UTILITY GROUND WIRE, SEE

DETAIL 1/E-2 FOR SIZE

COMPOUND GROUNDING PLAN

GROUNDING RISER KEY NOTES:


- AIR TERMINAL, BONDED w/ 2 AWG SOLID TINNED BCW, EXOTHERMIC WELD DIRECT TO TOWER OR USING VANCOMM, INC. CLAMP
- 2 ANTENNA MOUNTING MAST, (TYP.)
- 3 PANEL ANTENNA (TYP.), (BY OTHERS)
- 4 2 AWG SOLID TINNED BCW, EXOTHERMIC WELD TO GROUND RING
- 5 TOWER BASE
- 6 2 AWG SOLID TINNED BCW,
 EXOTHERMIC WELD TO TOWER BASE PL
 & EXOTHERMICALLY WELDED TO
 TOWER GROUND RING, (TYP. 3,
 EQUALLY SPACED)
- 7 TOWER FOUNDATION
- B TOWER GROUND RING: 2 AWG SOLID TINNED BCW, SPACE @ 2'-0" FROM TOWER FOUNDATIONS MIN., 5/8" \$\phix10' LONG COPPER CLAD STEEL GROUND RODS @ (10'-0" O.C. ±1'), @ 30" BELOW GRADE OR 6" BELOW FROST LINE WHICHEVER IS DEEPER (MIN.)

GENERAL NOTES:

- SUPPORT CLAMPS FOR GROUND WIRES
 SHALL BE NONMETALLIC.
- INTERIOR GROUND WIRES SHALL BE STRANDED GREEN INSULATED CU.
- GROUNDING SYSTEM TO MAINTAIN A GROUNDING RESISTANCE OF 5 OHMS OR LESS.
- 4. METALS WITHIN 6' (SIX FEET), OF GROUND RING SHALL BE BONDED w/ EXOTHERMIC WELD & 2 AWG SOLID TINNED BCW, GROUND WIRE.

ANTI-THEFT NOTES:

1. GROUND BARS AT ACCESSIBLE HEIGHT FOR POTENTIAL VANDALISM SHALL BE CONNECTED BY REPLACING THE KIT PROVIDED BOLTS W/ A SAME SIZED TAPCO TUFBOLT #(180-37) W/ A TAPCO 3/8" TUFNUT #(180-7) OR APPROVED EQUAL VANDAL-PROOF HARDWARE.

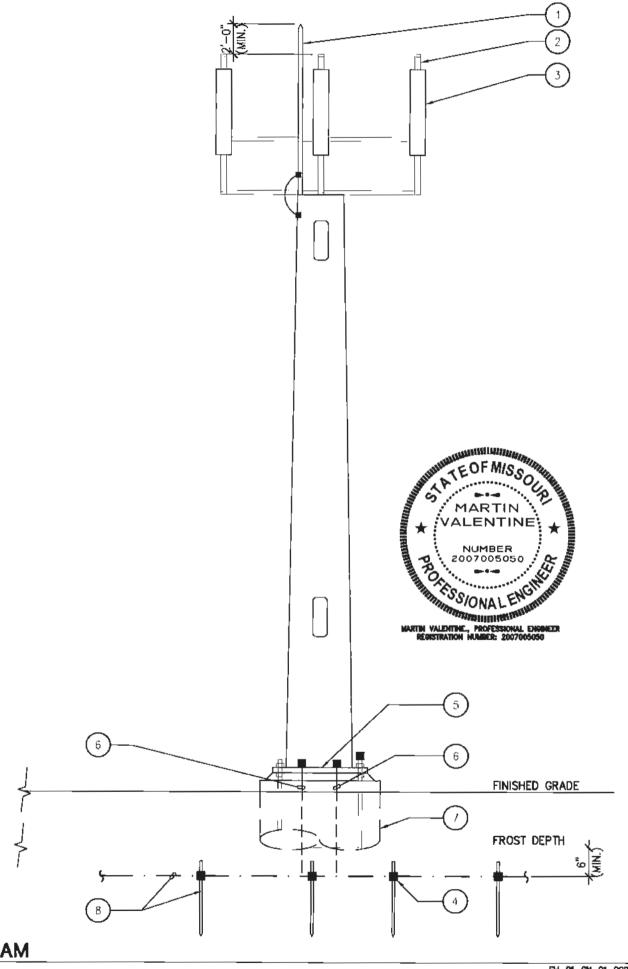

SHEET TITLE GROUNDING RISER

SHEET NUMBER

E-4

MEXICO &

SONDEREN

SITE# MO-2014-19

8388 MEDICO RDAD OTALLON, MO 63368 ST. CHARLES COUNTY

MONOPOLE

PROJECT NO: 8156607 DRAWN BY: JAP

0 8/3/15 CLENT REVIEW 1 9/23/15 BID/PERMIT 2 11/02/16 CITY COMMENTS 3 11/24/15 BIG REVIEW


CHECKED BY: JMD

 \Box

TYPICAL GROUNDING RISER DIAGRAM

SCALE: NONE


5H-01-CN-01-0028

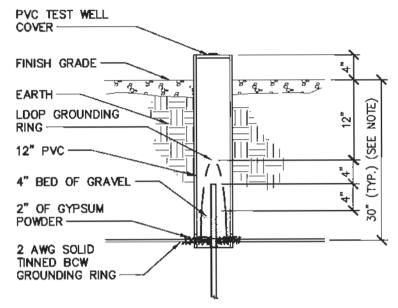

NOTE: 6" BELOW FROST DEPTH, DEPTH MAY VARY, WORK SHALL CONFORM TO THE LOCAL BUILDING

INSPECTION WELL DETAIL


SH-01-GN-05-002

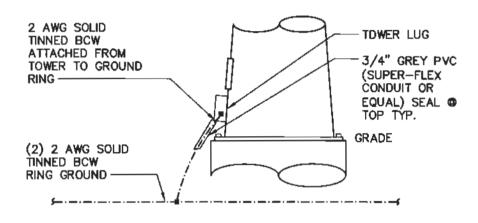

TOWER GROUNDING DIAGRAM

SCALE: NONE

TCO-01-GN-05-001

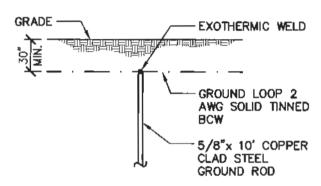


GROUND ROD SCALE: NONE

SH-01-GN-05-007

TCO-01-GN-05-010



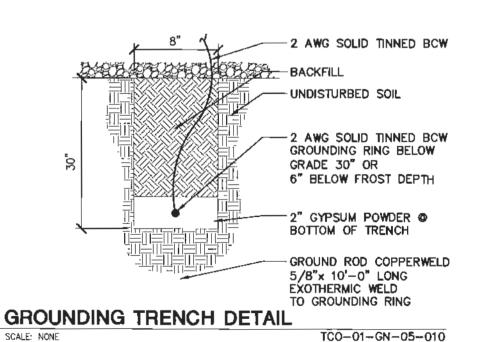

S PROJECT NO: 8156607 DRAWN BY: JAP CHECKED BY: JMD 0 8/5/15 CLIENT REVIEW 1 9/23/15 BID/PERMIT 2 11/02/15 CITY COMMENTS 3 11/24/15 ENG REVIEW

> MEXICO & SONDEREN

SITE# MO-2014-19 8388 MEDICO ROAD O'FALLON, MO 63388 ST. CHARLES COUNTY

> SHEET TITLE GROUNDING DETAILS

MONOPOLE

SHEET NUMBER

E-5